

**STATE OF GEORGIA  
COUNTY OF COWETA**

**INTERGOVERNMENTAL AGREEMENT  
BETWEEN COWETA COUNTY, GEORGIA AND THE CITY OF SENOIA  
FOR ASSISTANCE WITH MARIMAC LAKES PARK**

THIS AGREEMENT (hereinafter "Agreement"), made and entered into this \_\_\_\_ day of \_\_\_\_\_, 2023, by and between COWETA COUNTY, GEORGIA, a political subdivision of the State of Georgia (hereinafter "County") and the CITY OF SENOIA, a political subdivision of the State of Georgia (hereinafter "City").

**WHEREAS**, the City owns and operates a park in the city known as Marimac Lakes Park (hereinafter "Park"); and

**WHEREAS**, the County and City agree that parks and recreational programs improve the physical and psychological health of residents, strengthen our communities, and make our neighborhoods more attractive places to live and work; and

**WHEREAS**, the City has requested that the County provide assistance to construct an emergency access drive and a multiuse asphalt trail in the Park (hereinafter "Project") as shown in Exhibit "A"; and

**NOW THEREFORE**, in consideration of the mutual covenants and promises herein made, the receipt, adequacy and sufficiency of which are mutually acknowledged, the County and the City agree to be bound, each to the other as follow:

**ARTICLE 1. - LEGAL AUTHORITY**

The County and the City are authorized to enter into an intergovernmental agreement in accordance with the authority granted by Article IX, Section III, Paragraph I of the 1983 Constitution of the State of Georgia. Each of the parties herein covenants that it has the requisite legal authority to provide the services, perform the functions, and otherwise do all things necessary, convenient, and expedient to carry out the obligations and responsibilities herein set forth, either expressly or by implication.

**ARTICLE 2. – DUTIES OF THE COUNTY**

2.1 The County shall provide the necessary labor, supervision, and equipment to complete the Project as shown in Exhibit "A", including any required contractors.

2.2 The County shall invoice the City for the cost of all materials and contractors used in completing the Project. Said invoices shall be submitted to the City within six (60) days of the incurred cost.

### ARTICLE 3. – DUTIES OF THE CITY

3.1 The City shall acquire and pay for the required National Pollutant Discharge Elimination System (“NPDES”) permit through the Georgia Environmental Protection Division (“EPD”), provide necessary permit documentation, and serve as the primary permittee.

3.2 The City shall provide all necessary documentation for the Project to the County, including but not limited to the NPDES permit, construction plans, and erosion control plans.

3.3 The City shall reimburse the County within thirty (30) days from the date of the invoice in accordance with Section 2.2.

### ARTICLE 4. – TERM AND TERMINATION

4.1 This Agreement shall be effective upon execution and shall remain in effect until the County completes the Project and receives full payment from the City as outlined in Article 3, unless terminated earlier by either party with thirty (30) days written notice. If this Agreement is terminated prior to the completion of the Project, the City shall pay the County for all costs incurred prior to termination.

### ARTICLE 5. – MISCELLANEOUS

5.1. Severability. If any provision of this Agreement is invalid or unenforceable with respect to any party, then the remainder of this Agreement, or the application of such provision to persons other than those as to whom it is held invalid or unenforceable, shall not be affected and each provision of this Agreement shall remain valid and enforceable to the fullest extent permitted by law; if fulfillment of any provision of this Agreement, or performance of any transaction related hereto, at the time such fulfillment or performance shall be due, shall involve transcending the limit of validity prescribed by law, then the obligation to be fulfilled or performed shall be reduced to the limit of such validity.

5.2. Binding Effect. This Agreement shall be binding on and inure to the benefit of the respective parties’ successors and permitted assignees.

5.3. Governing Law. This Agreement shall be construed by the laws of the State of Georgia. The parties consent to the venue and jurisdiction of the Superior Court of Coweta County, Georgia.

5.4. Captions and Recitals. The captions and recitals of this Agreement are to be construed as part of this Agreement.

5.5. No Waiver. No provision of this Agreement shall be deemed to have been waived by either party unless the waiver is in writing and signed by the party against whom enforcement is attempted.

5.6. Notice. Any notice required to be given in this Agreement will be made to the address of other parties set forth below:

County:

Coweta County, Georgia  
Attn: County Administrator  
22 East Broad Street  
Newnan, Georgia 30263

City:

City of Senoia, Georgia  
Attn: City Manager  
105 Main Street  
Sharpsburg, Georgia 30277

IN WITNESS WHEREOF, the County and City have executed this Agreement as of the date first above written.

Coweta County, Georgia

City of Senoia, Georgia

By: \_\_\_\_\_  
Chairman

By: \_\_\_\_\_  
Mayor

Attest: \_\_\_\_\_  
Clerk

Attest: \_\_\_\_\_  
Clerk

(SEAL)

(SEAL)

## **EXHIBIT “A”**

**GENERAL NOTES:**



- ENGINEER/SURVEYOR:  
INTEGRATED SCIENCE & ENGINEERING, INC.  
1039 SULLIVAN ROAD, STE. 200  
NEWTOWN, GA 30285  
CONTACT: DANA S. JOHNSON, PE  
EMAIL: D.JOHNSON@INTSECO.COM  
PHONE: 678-552-2106
- PROPERTY OWNER:  
THE CITY OF SENOIA  
801 MAIN STREET  
SENOIA, GA 30276  
CONTACT: CURTIS HANDMAN  
(770) 994-4675
- ZONING: N/A EXEMPT
- TOTAL SITE AREA = 16.73 AC.
- DISTURBED AREA = 0.25 AC.
- INFILTRATION AREA = 0.66 AC.
- 24-HOUR CONTACT: CURTIS HANDMAN, 678-487-7553
- STATE WATERS ARE PRESENT ON THIS PROJECT SITE AS INDICATED, HOWEVER ARE NOT AFFECTED BY THIS DEVELOPMENT.
- WETLANDS WERE IDENTIFIED WITHIN THE PROPERTY BOUNDARIES AND ARE AFFECTED BY THIS PROJECT. AFFECTED AREA = 0.02 AC.
- THIS PROPERTY IS LOCATED WITHIN A FLOOD HAZARD ZONE ACCORDING TO FELA FLOOD INSURANCE RATE MAP FOR COVETA COUNTY, COMMUNITY PANEL M470207 DATED FEB. 02, 2013.
- ALL WORK SHALL CONFORM TO COVETA COUNTY STANDARDS AND SPECIFICATIONS. IT IS THE CONTRACTORS RESPONSIBILITY TO NOTIFY THE PROPER OFFICIALS FOR ANY REQUIRED INSPECTIONS.
- FEA FLOOD INSURANCE RATE MAP FOR COVETA COUNTY, COMMUNITY PANEL M470207 DATED FEB. 02, 2013.
- THE CONTRACTORS RESPONSIBILITY IS TO NOTIFY THE PROPER OFFICIALS FOR ANY REQUIRED INSPECTIONS.

Sheet Number	Sheet Title
C001	COVER
C002	GENERAL NOTES
C003	EXTREME CONDITIONS
C004	EXISTING CONDITIONS
C005	EXISTING CONDITIONS
C006	SITE LOCATION
C007	SITE PLAN
C008	BRODING AND DRAINS
C009	GRADING AND DRAINS
C010	CAST PAV. GRADING AND DRAINS
C011	UPGRADED RD. GRADING AND DRAINS
C012	STREAM PIPE PROFILES
C013	WATER MAIN PLAN
C014	WATER MAIN PLAN
C015	WATER MAIN PLAN
C016	EROSION CONTROL COVERING
C017	COMPREHENSIVE MONITORING PLAN
C018	N.P.D.A. CHECKLIST
C019	PRE-DEVELOPMENT DRARRIER BARRIERS
C020	POST-DEVELOPMENT DRARRIER BARRIERS
C021	INITIAL FLOW EROSION AND SEDIMENTATION CONTROL PLAN
C022	INTERIM/TRANSITION PHASE EROSION AND SEDIMENTATION CONTROL PLAN
C023	FINAL DRAYAGE EROSION AND SEDIMENTATION CONTROL PLAN
C024	EROSION TENTS
C025	SPRINKLER DETAILS
C026	PROTECTION DETAILS
C027	CONSTRUCTION DETAILS
C028	CONSTRUCTION DETAILS

# SITE DEVELOPMENT PLANS FOR HOWARD ROAD CART PATH

LAND LOT 260 OF THE 1ST DISTRICT, CITY OF SENOIA, COVETA COUNTY, GEORGIA

SITE LOCATION MAP

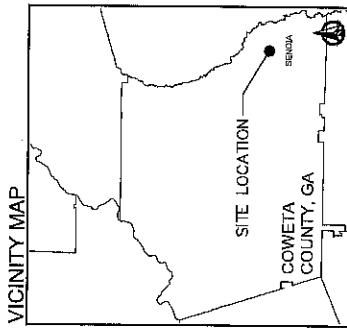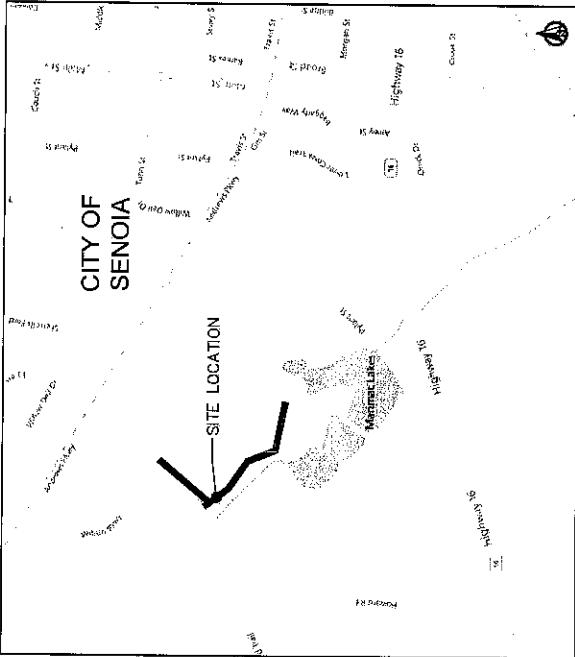

PREPARED FOR:  
**THE CITY OF SENOIA**

INTEGRATED  
SCIENCE &  
ENGINEERING



HOWARD ROAD CART PATH  
THE CITY OF SENOIA  
THE DEVELOPMENT TEAM FOR  
LNG LOT 260 OF THE 1ST DISTRICT, CITY OF SENOIA, COVETA COUNTY, GEORGIA

COVER

DRAWING NO.  
C000




LAND LOT 269 OF THE 5TH DISTRICT, CITY OF SENOIA, COWETA COUNTY, GEORGIA

STATE REGULATORY PLAN FOR THE CITY OF SENOIA  
HOWARD ROAD CART PATH

EXISTING CONDITIONS

DRAWING NO. C100

100	100	100	100
100	100	100	100
100	100	100	100
100	100	100	100

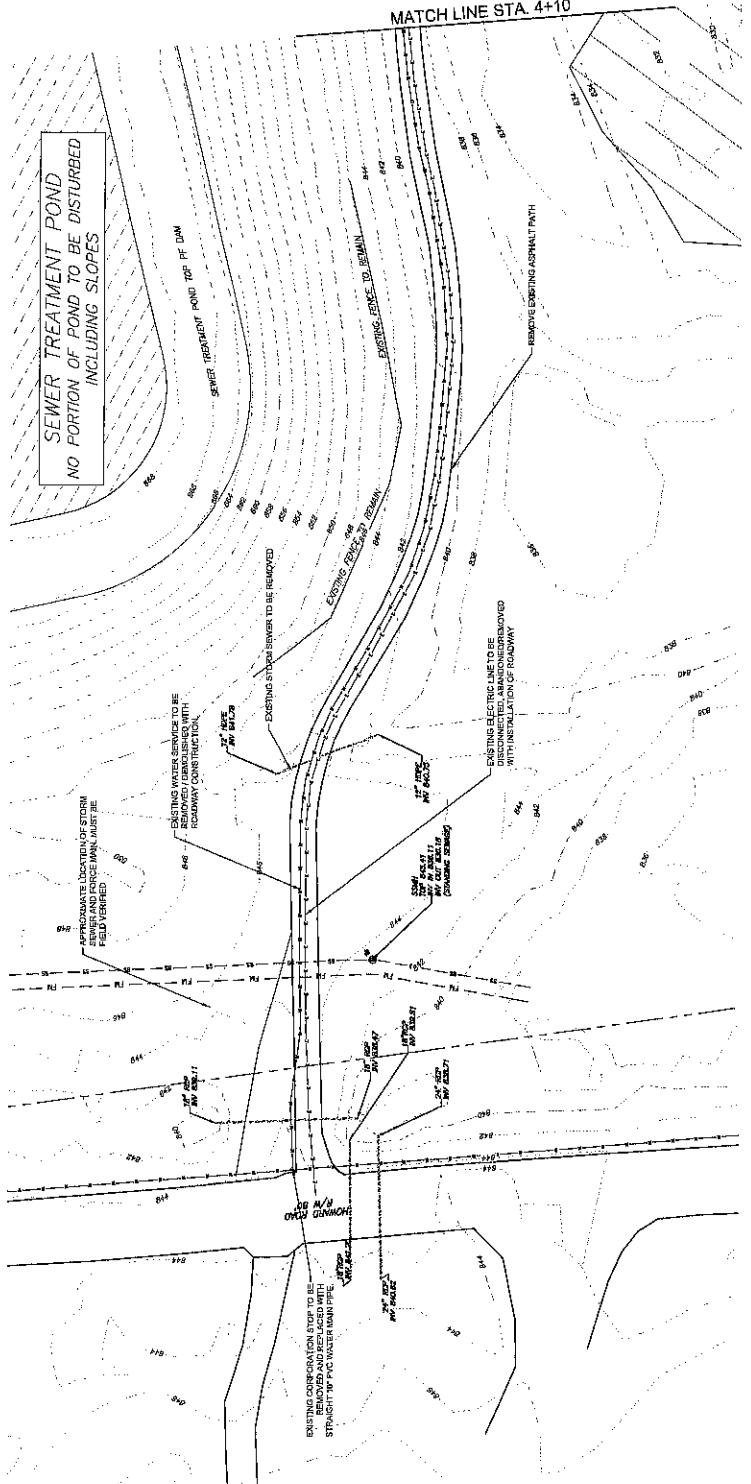

DRAWING NO.  
C101






EXISTING CONDITIONS

LAND LOT 262 OF THE 1ST DISTRICT CITY OF SAVANNAH, CEMERA COUNTY, GEORGIA

HOWARD ROAD CART PATH  
THE CITY OF SAVANNAH  
SITE DEVELOPMENT PLAN FOR

INTEGRATED  
Solutions

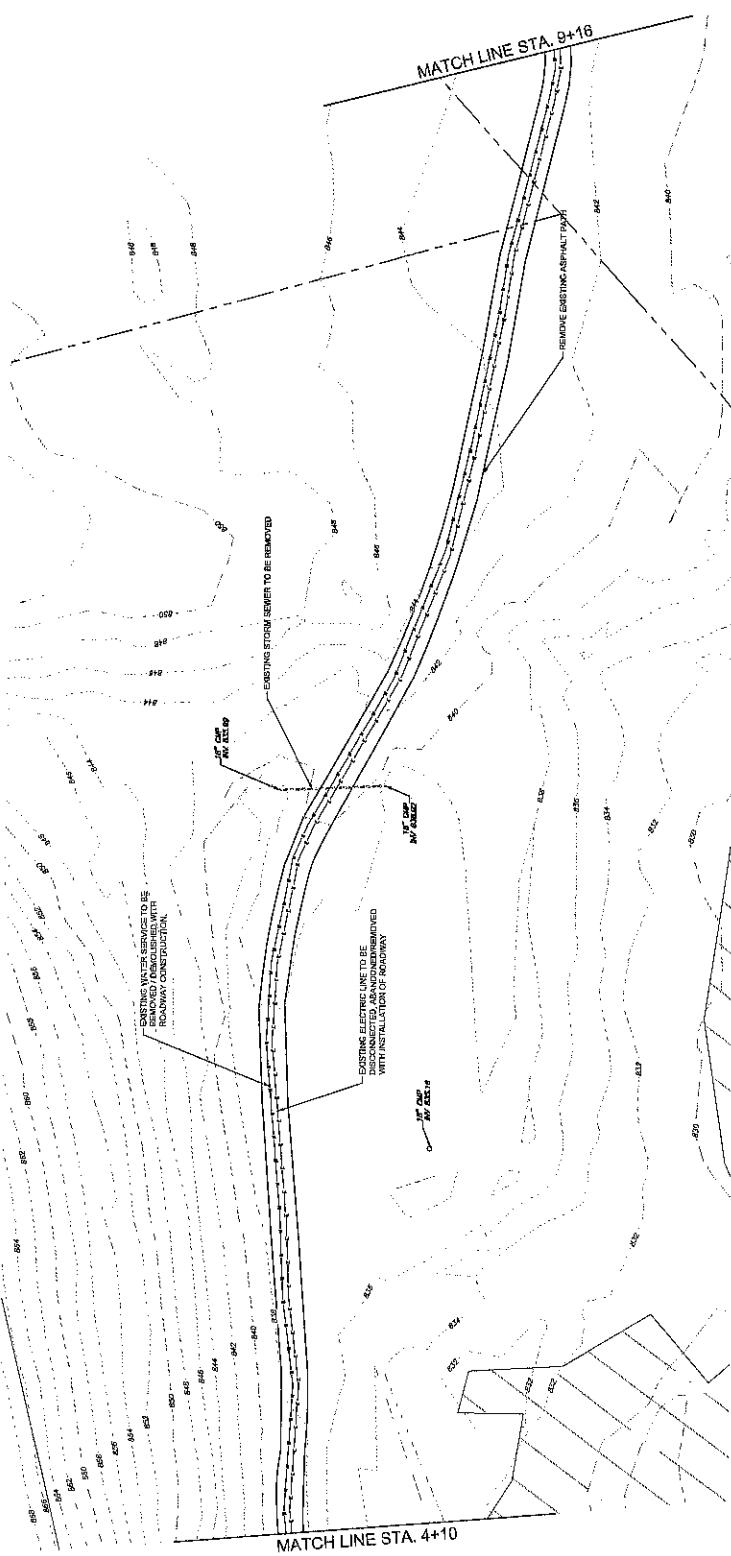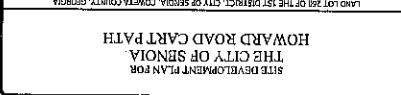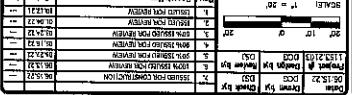

DRAWING NO.  
C102



EXISTING CONDITIONS

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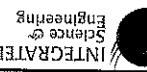
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HOWARD ROAD CART PATH


THE CITY OF SENOIA

STATE DEVELOPMENT PLAN FOR

THE CITY OF SENOIA

HOWARD ROAD CART PATH

EXISTING CONDITIONS

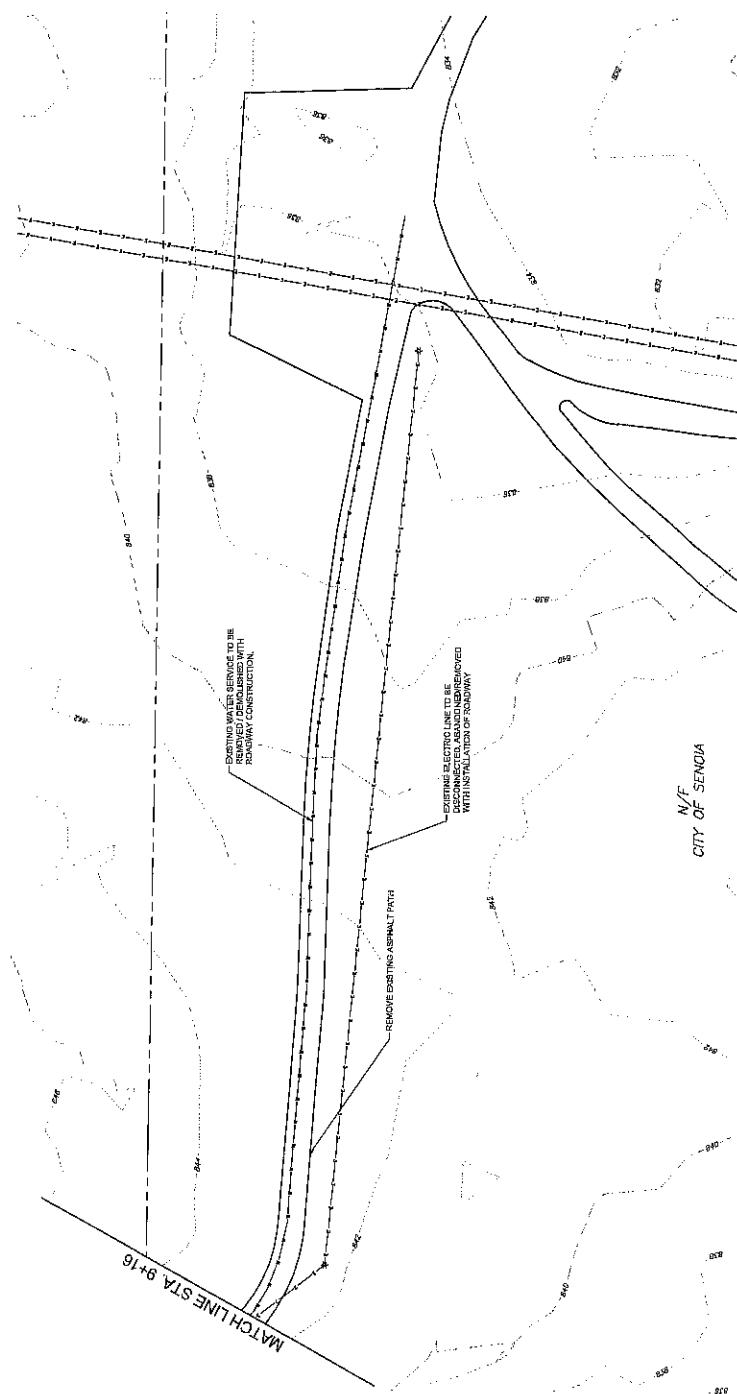

N/F  
CITY OF SENOIA

LAND USE ZONE OF THE SITE DISTRICT, CITY OF SENOIA, GA. PLAT COMPARATIVE GROUPING

THE CITY OF SENOIA  
SITE DEVELOPMENT PLAN FOR  
HOWARD ROAD CARTRIDGE PATH

1. SEWER TREATMENT POND	2. SEWER TREATMENT POND	3. SEWER TREATMENT POND	4. SEWER TREATMENT POND
NO PORTION OF POND TO BE DISTURBED	INCLUDING SLOPES		


INTENDED  
SCHEME  
Engineering

GA. STATE PLANNING COMMISSION  
RECEIVED BY THE STATE PLANNING COMMISSION ON  
MAY 23, 2002  
RECEIVED BY THE STATE PLANNING COMMISSION ON  
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MAY 23, 2002

SITE PLAN

DRAWING NO.  
C200

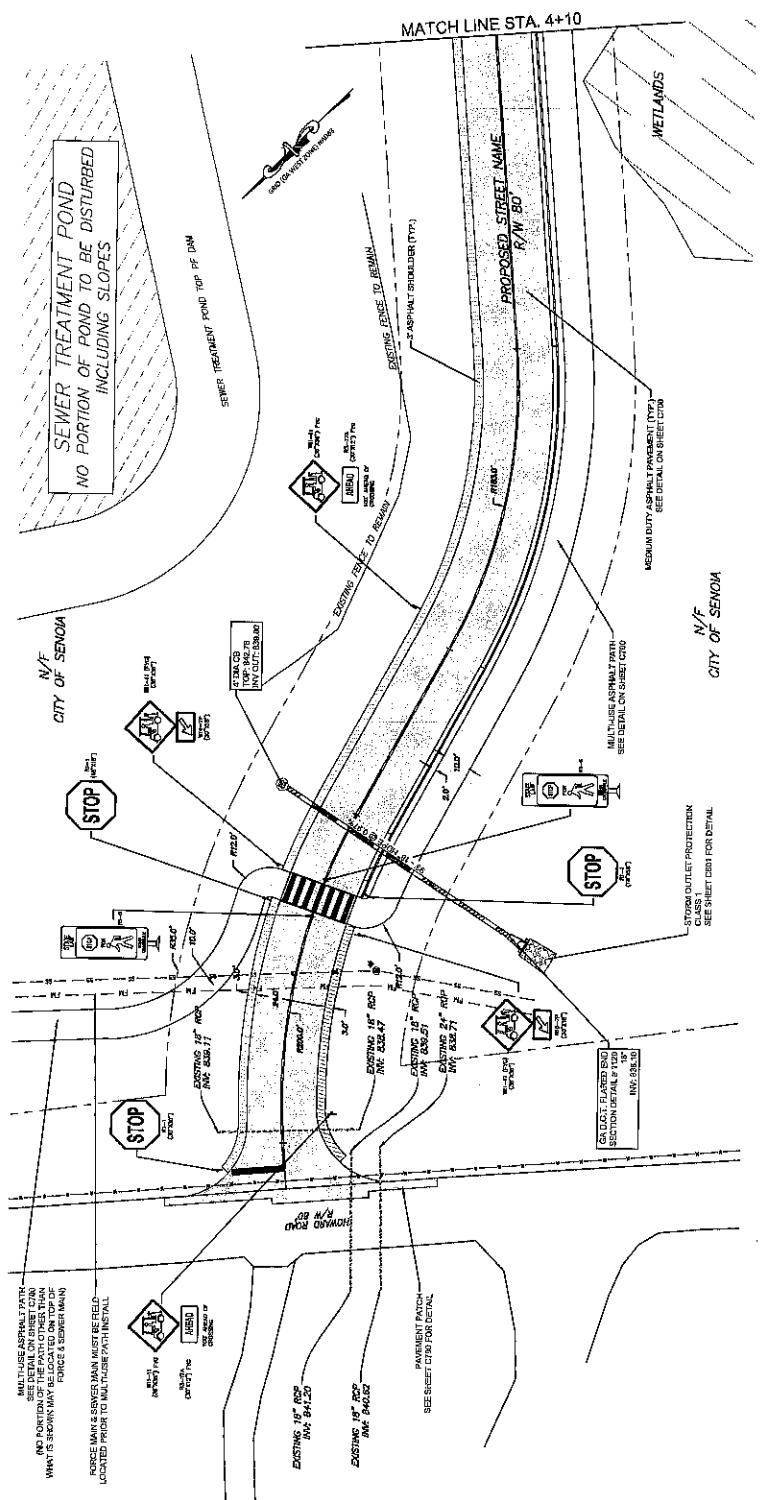


SITE PLAN LEGEND:

- - - PROPERTY LINE - SEE PLAT FOR DETAILS
- - - DOUBLE BIRD CATCH BASIN
- - - SPREAD WING DITCH BASIN
- DROP INLET
- STORM PIPE - SEE PROFILE ON SHEET C200
- MEDIUM CITY ASPHALT PAVEMENT - SEE DETAIL ON SHEET C200
- KIP ROAD EROSION PROTECTION
- STEEL POST



INTEGRAILED		Engineering	
SCHEMATIC		Site Development Plan for Howard Road Cart Path	
LAND LOT #6 OF SITE DISTRICT CITY OF SENOIA, GWINNETT COUNTY, GEORGIA			
THE CITY OF SENOIA			
SITE DEVELOPMENT PLAN FOR HOWARD ROAD CART PATH			
DRAWING NO. C201			

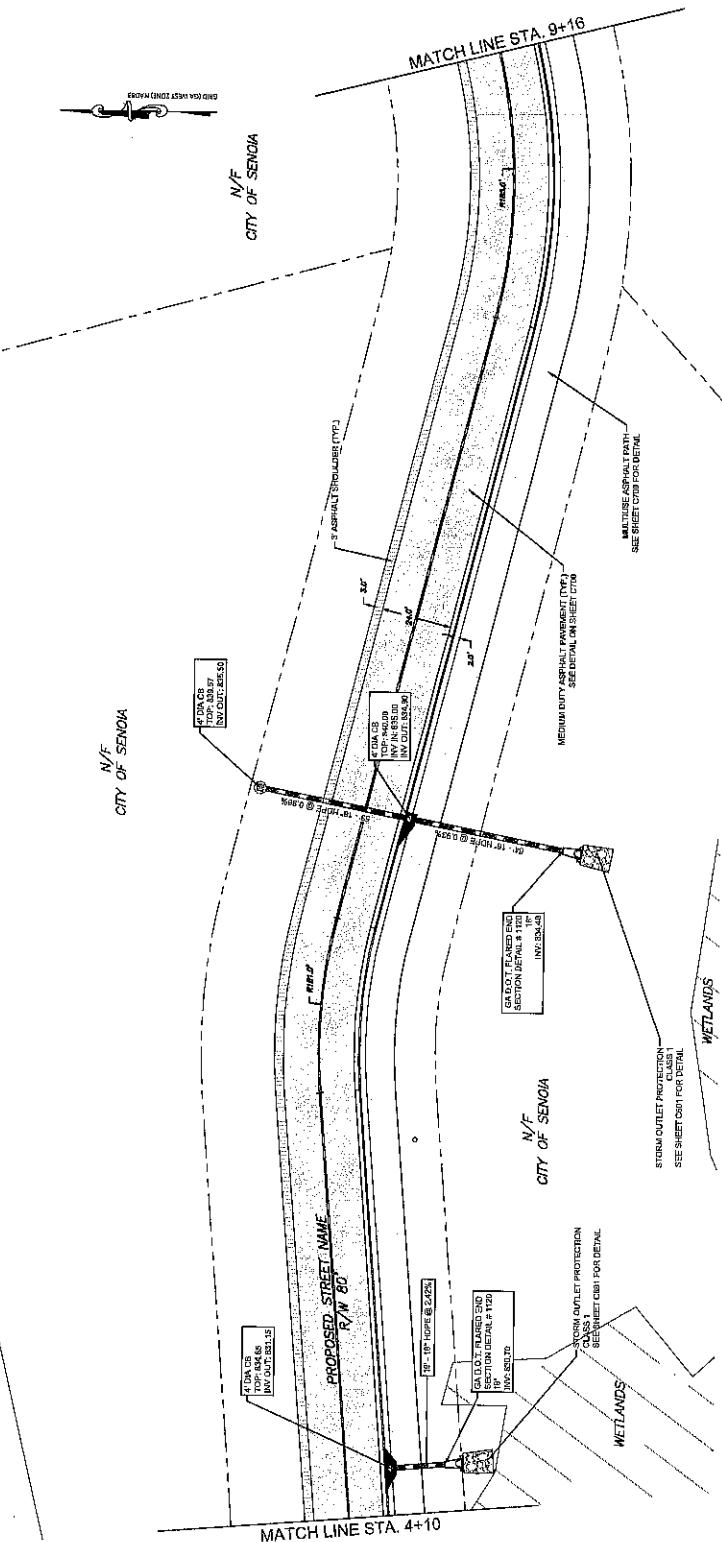

#### SITE PLAN LEGEND:


- = PROPERTY LINE - SEE PLAT FOR DETAILS
- = DOUBLE WING CATCH BASIN
- = SINGLE WING CATCH BASIN
- ◎ = DROP INLET
- = STORM PIPE - SEE PROFILE ON SHEET CT00 AND PIPE BORROWING DEFINED ON SHEET CT00
- ✖ = PROPOSED LIGHT POLE
- = ASPHALT SHOULDER
- = MATERIALS ASPHALT PATH - SEE DETAIL ON SHEET CT00
- = MEMORANDUM OF UNDERSTANDING (MOU) SEE SHEET CT00
- = RIP RAP EROSION PROTECTION
- = SHORE BANK



INTEGRATED Engineering		SCHLEGEL & CO.	
Site Development Plan		Land Lot 260 of the 15th District, City of Senoia, Coweta County, Georgia	
THE CITY OF SENOIA		STREET DEVELOPMENT PLAN FOR HOWARD ROAD CARPARK	
Lot 260, Block 15, District 15, City of Senoia, Coweta County, Georgia		Land Lot 260 of the 15th District, City of Senoia, Coweta County, Georgia	
INTEGRATED Engineering		SCHLEGEL & CO.	

DRAWING NO.  
C202  
Georgia  
Engineering Company, Inc.  
www.schlegel.com

SITE PLAN

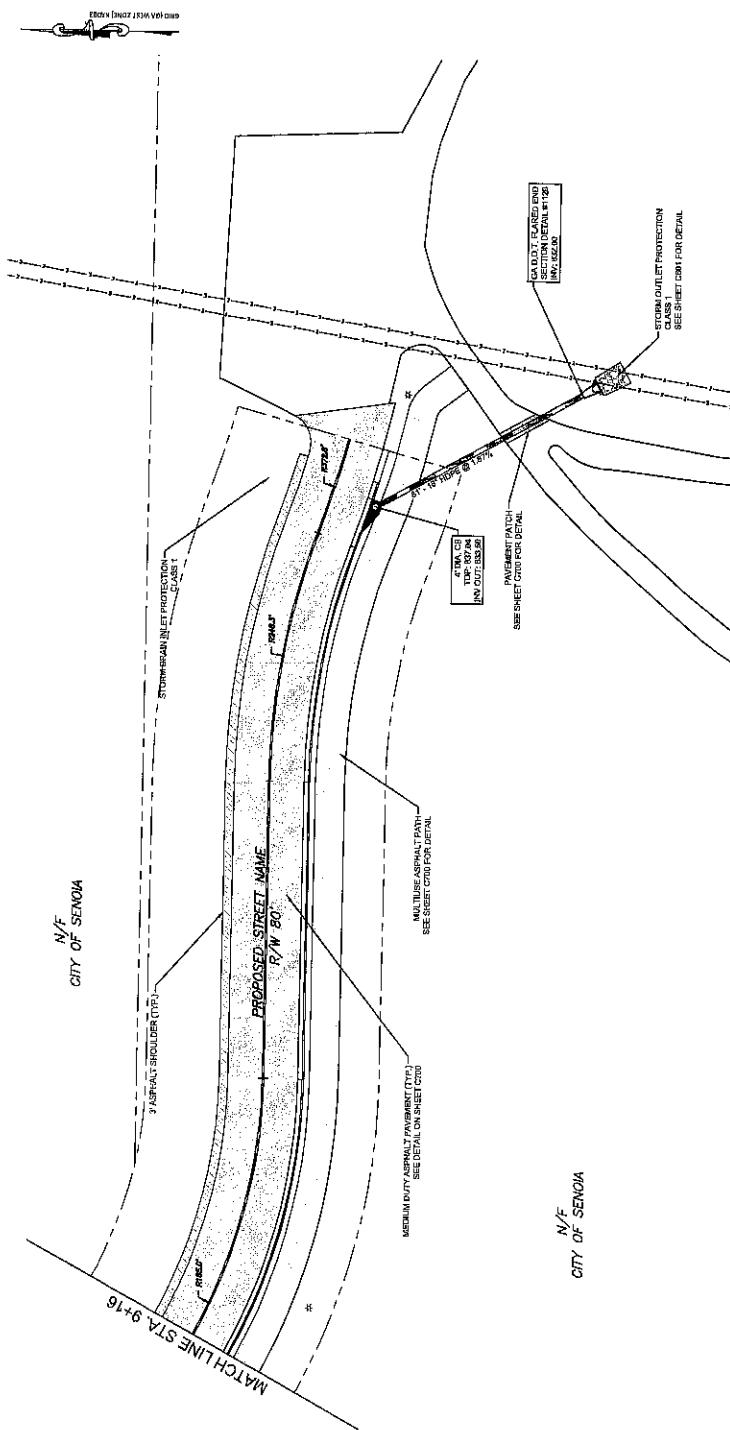

SITE PLAN LEGEND:

- - - = PROPERTY LINE - SEE PLAT FOR DETAILS
- [Dashed Line] = PROPOSED CONCRETE CURB
- [Double V shape] = DOUBLE V-SHAPED CATCH BASIN
- [Single V shape] = SINGLE V-SHAPED CATCH BASIN
- [Circle with dot] = DROPOUT INLET
- [Square] = STORM PIPE - SEE PROPS ON SHEET C202
- \* = PROPOSED LIGHT POLE
- [Square with diagonal line] = ASPHALT SHOULDER
- [Square with diagonal line] = MULTIPLE ASPHALT PATH - SEE DETAIL ON SHEET C202
- [Square with diagonal line] = ASPHALT SHOULDER - SEE DETAIL ON SHEET C202
- [Square with diagonal line] = RIP RAP EROSION PROTECTION
- [Circle] = SIGN POST


INTECRATED		Engineering	
SCIENCE			
LAND USE SITE PLAN DESIGN, SITE OF SEENOIDA STATE DEVELOPMENT PLAN FOR THE CITY OF SEENOIDA HOLLOW ROAD CARTH PATH DRAWING AND DRADING			
DRAWING NO. C300			

GRADING AND DRAINAGE NOTES:

- SEE SHEET ONE FOR ADDITIONAL GRADING AND DRAINAGE NOTES.
- GRADE LINES INDICATED ON SHEET ONE. ROADWAY CROSS SECTIONS ON SHEET ONE.
- NO PORTION OF THIS PROPERTY IS LOCATED IN A "ZONE A" FLOOD HAZARD AREA ACCORDING TO THE FEDERAL HAZARD RATE MAP FOR BULLOVA COUNTY, GEORGIA, PUBLISHED BY THE UNITED STATES GEOLOGICAL SURVEY, SEPTEMBER 19, 2013.
- STORMWATER MANAGEMENT AND WATER QUALITY TO BE PROVIDED ON-SITE VIA GROINED SWALE.

PLAN LEGEND:


- DOUBLE VING CATCH BASIN
- SINGLE VING CATCH BASIN
- DROP INLET
- STORM PIPE SIZE, PIPES ARE ON SHEET COLD.
- ROD — PROPOSED CONTOURS
- ROD — PROPOSED LIGHT POLE

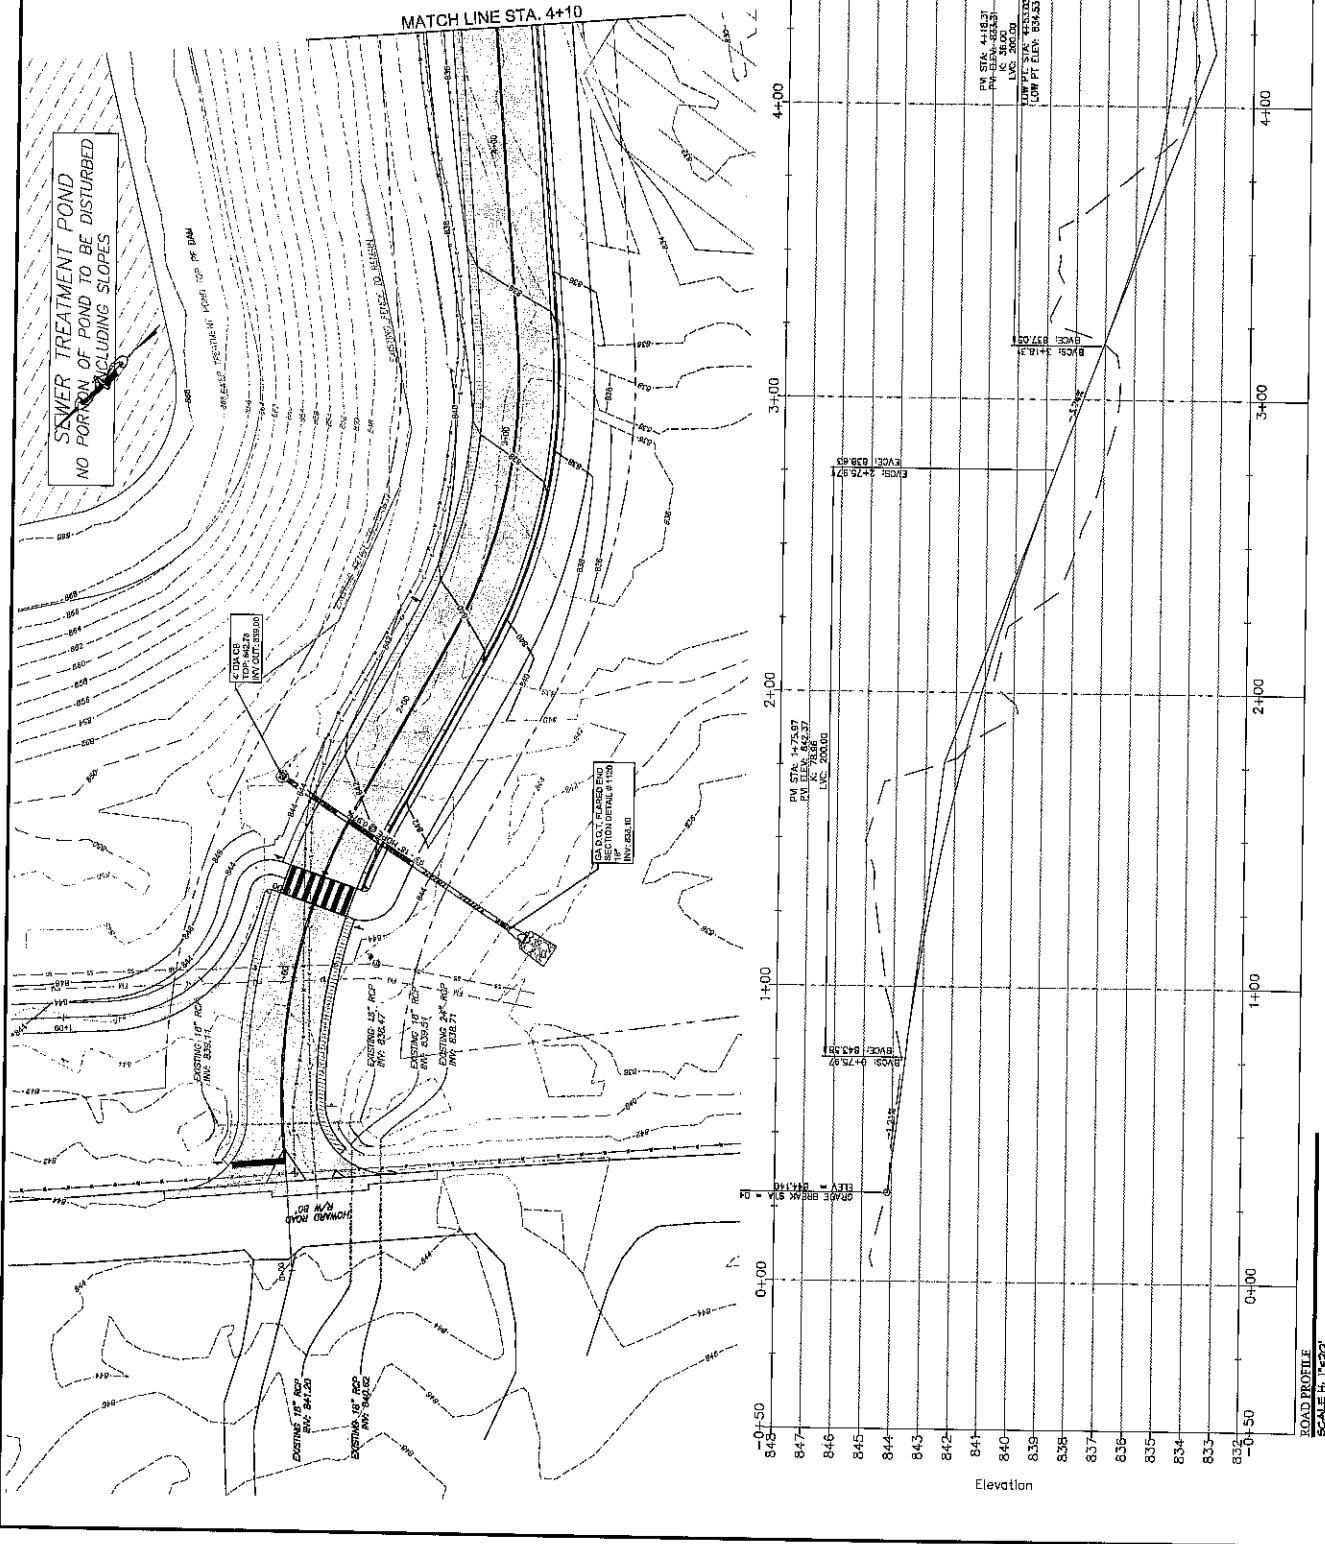

www.dnr.state.ga.us

Division of Water Resources

Water Protection

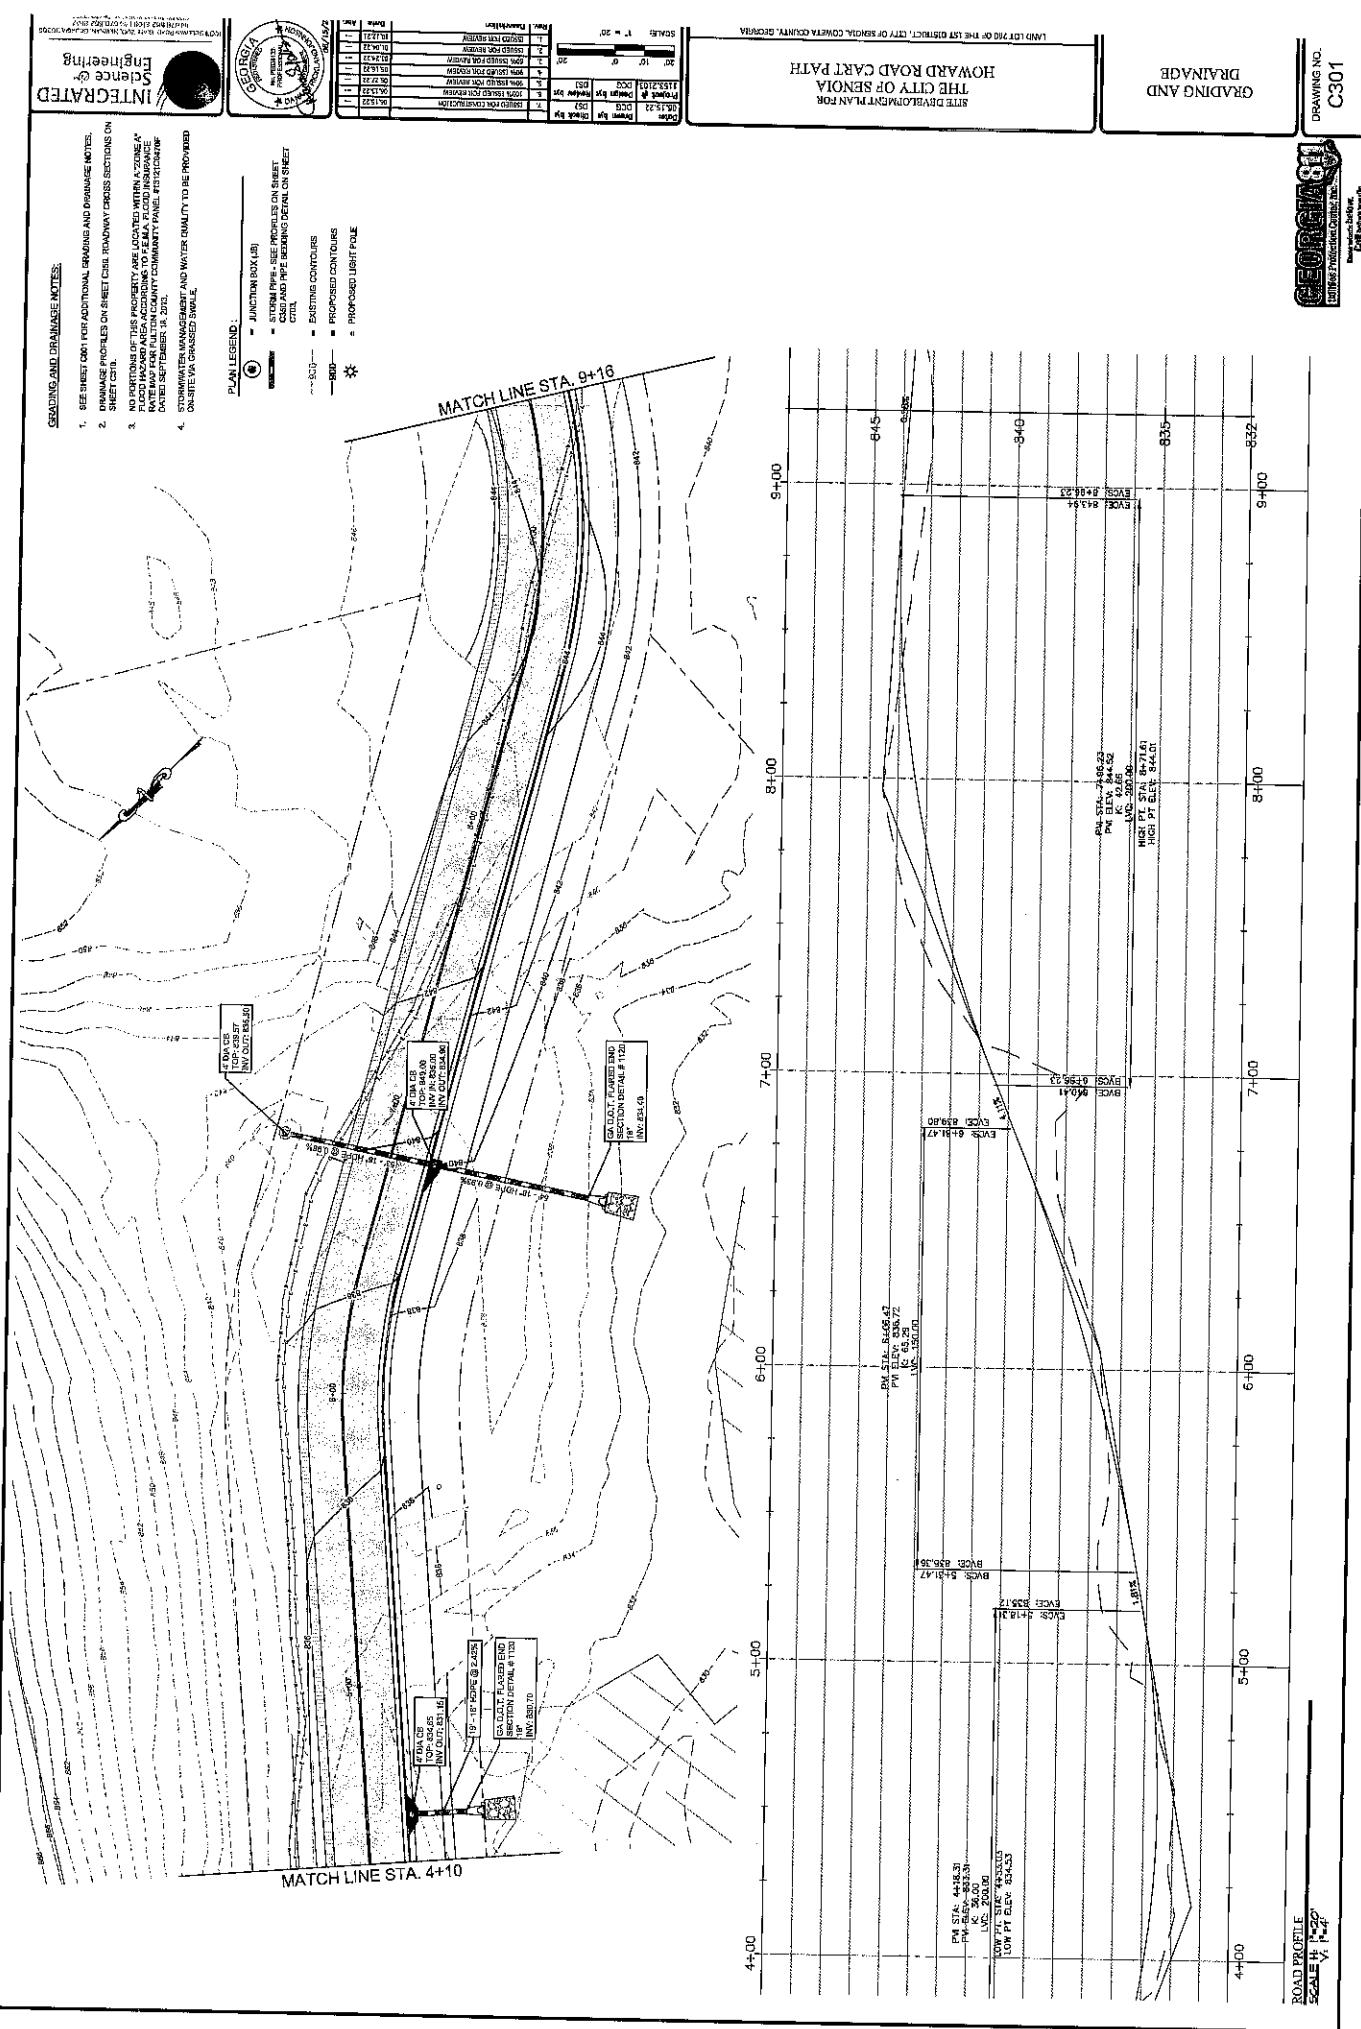

DRAINING AND

DRAWING NO.  
C302

LAND LOT 209 OF THE 1ST DISTRICT, CITY OF SENOIA, COVINGTON COUNTY, GEORGIA

Scales	1" = 30'
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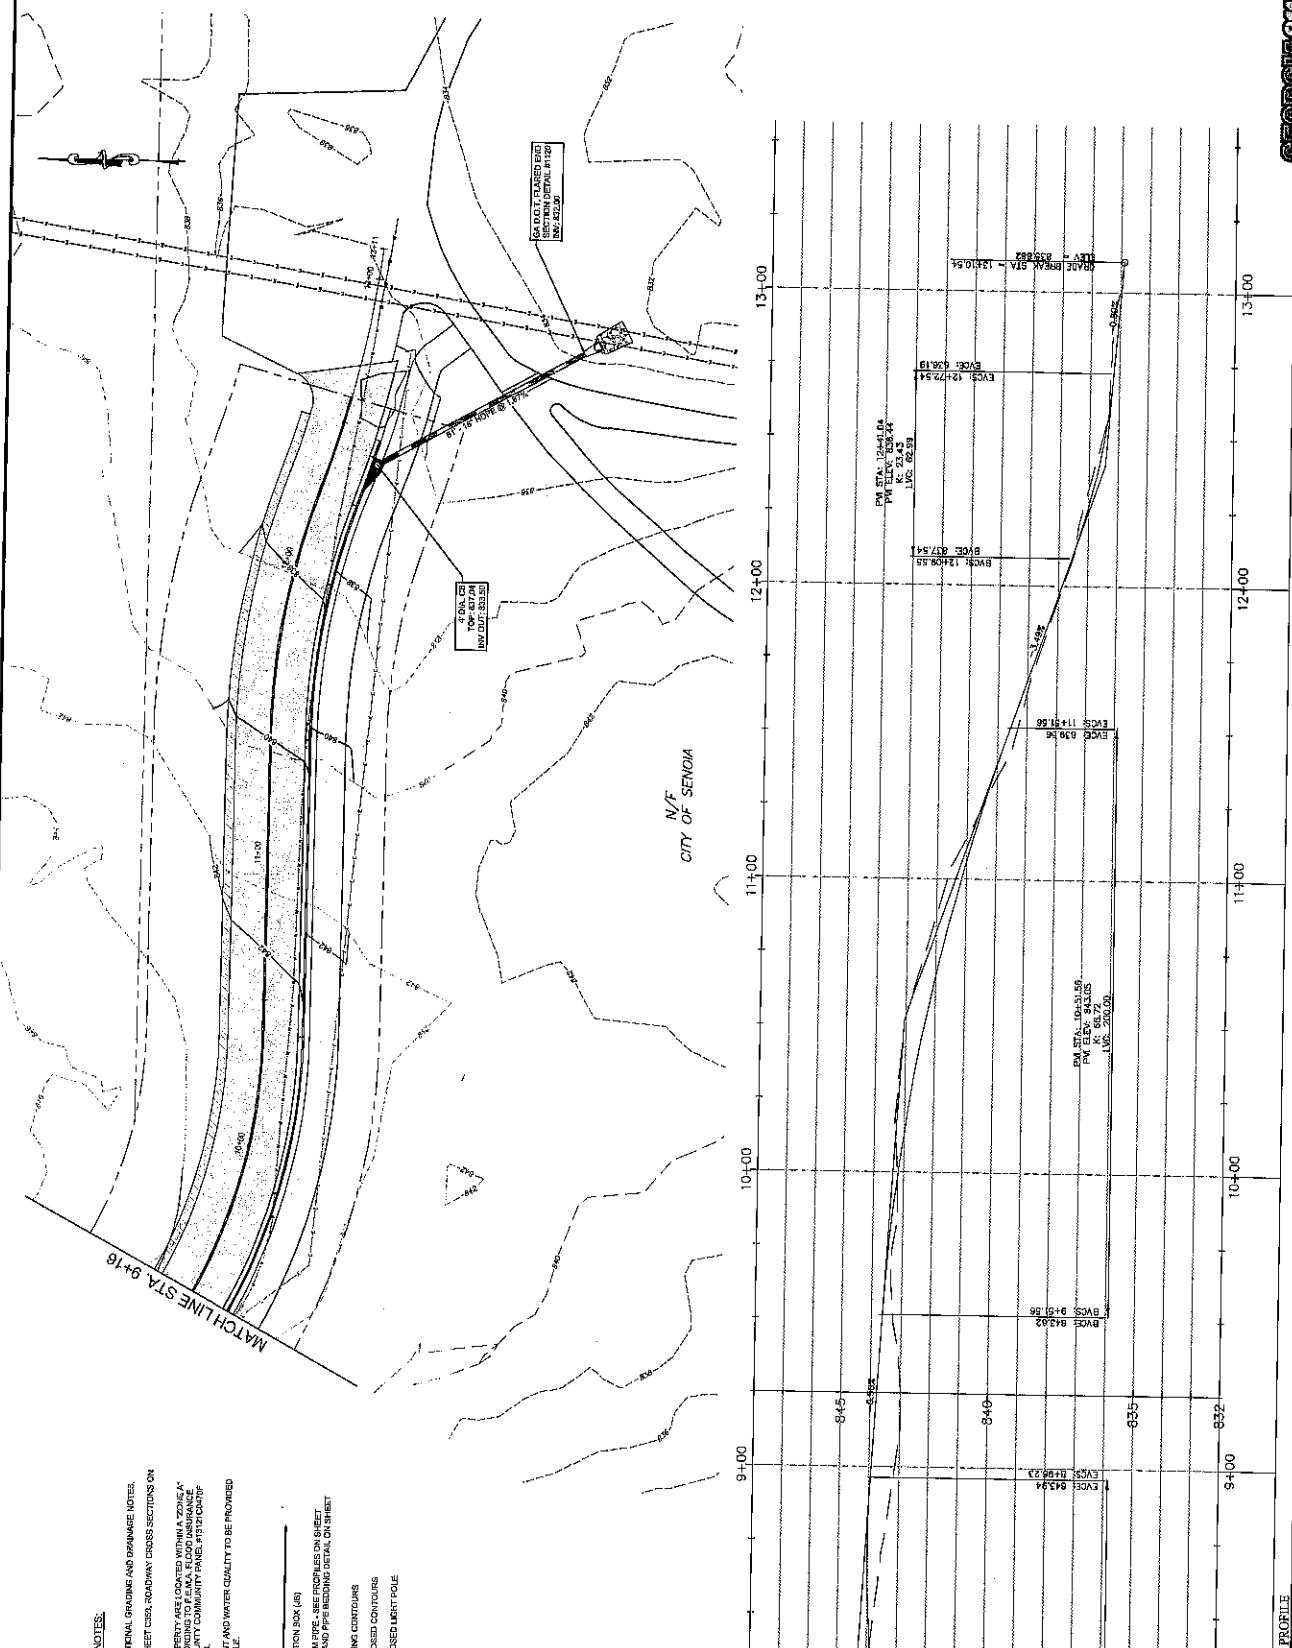
**GRADING AND DRAINAGE NOTES:**


1. SEE SHEET ONE FOR ADDITIONAL GRADING AND DRAINAGE NOTES.
2. ORANGE PROFILES IN SHEET C302, ROADWAY CROSS SECTION ON
3. NO PORTIONS OF THIS PROPERTY ARE LOCATED WITHIN A ZONE A<sup>1</sup> AS DEFINED IN THE NATIONAL FLOOD INSURANCE RATE MAP FOR FLATWOODS COMMUNITY PARK, FILED SEPTEMBER 16, 2011.
4. STORMWATER MANAGEMENT AND WATER QUALITY TO BE PROVIDED ON SITE VIA GRASSED SWALE.

**PLAN LEGEND:**



- = ADJUSTMENT BOX (AS)
- = EXISTING PIPE, SEwer, GROUNd, O' STREET
- = NEW PIPE, SEwer, GROUNd, O' STREET
- = EXISTING CONTOURS
- = PROPOSED CONTOURS
- = PROPOSED LIGHT POLE


ROAD PROFILE








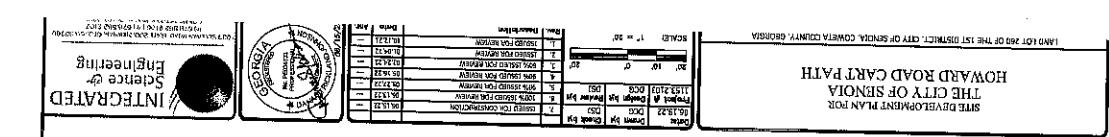


DRAWING NO.  
C303

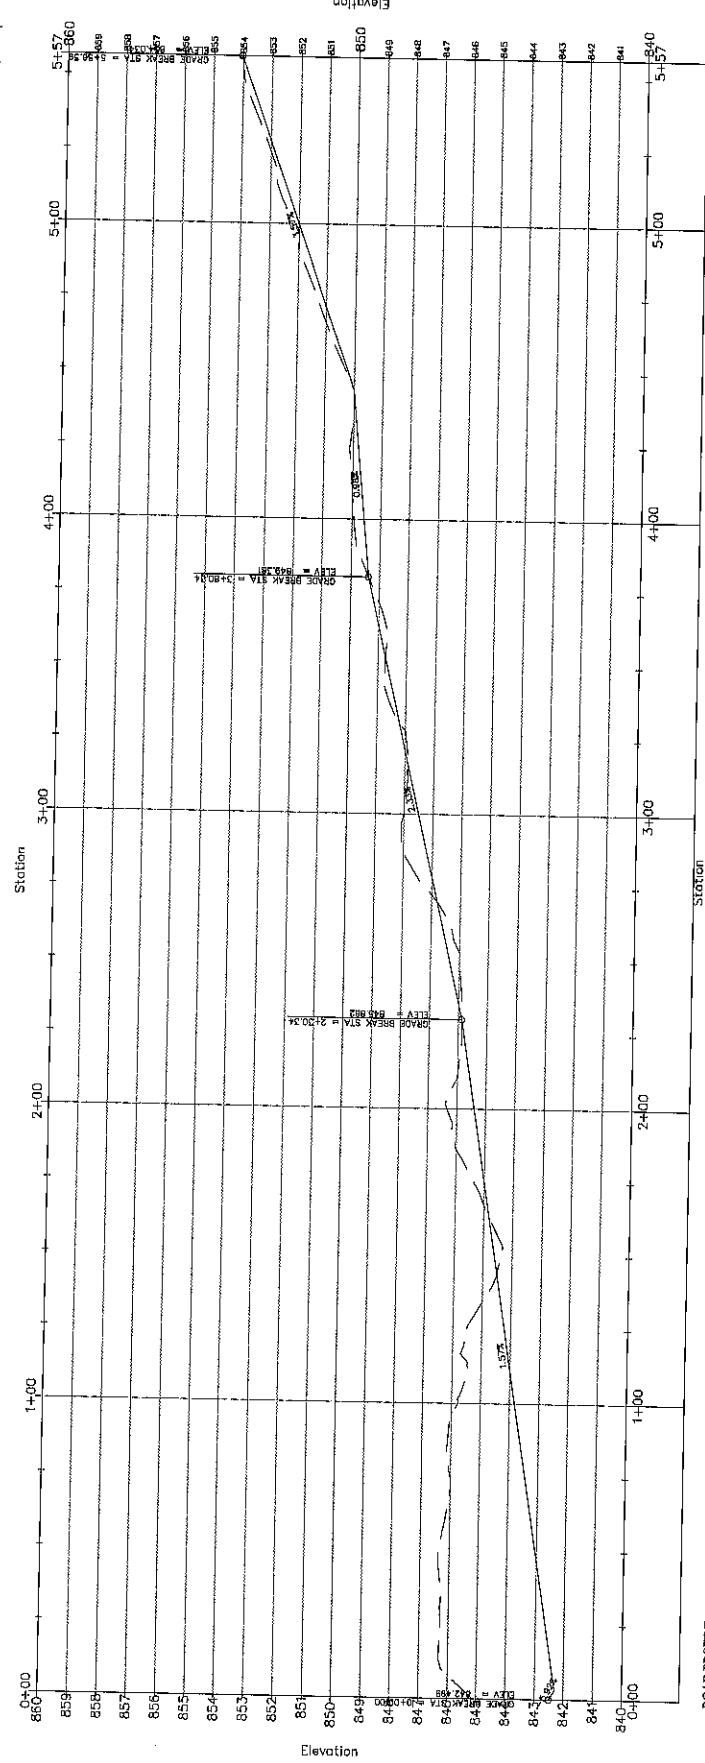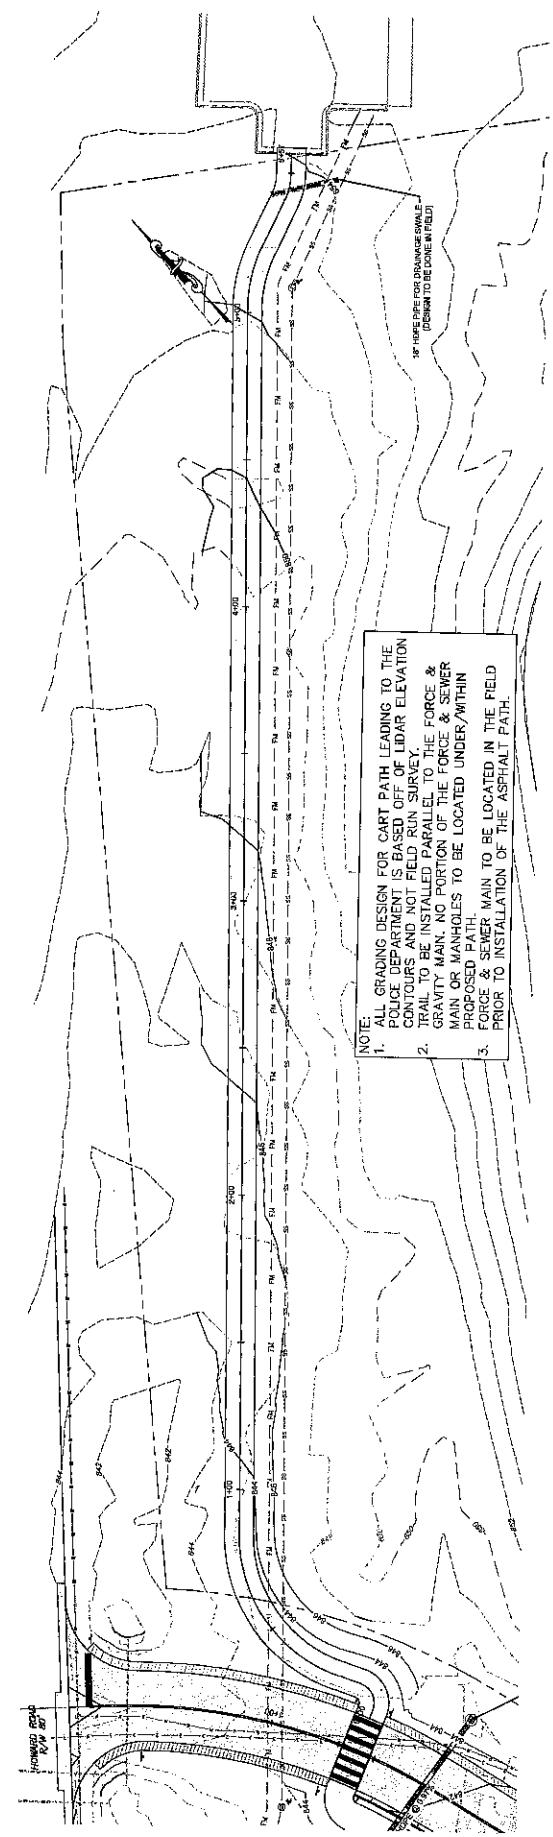

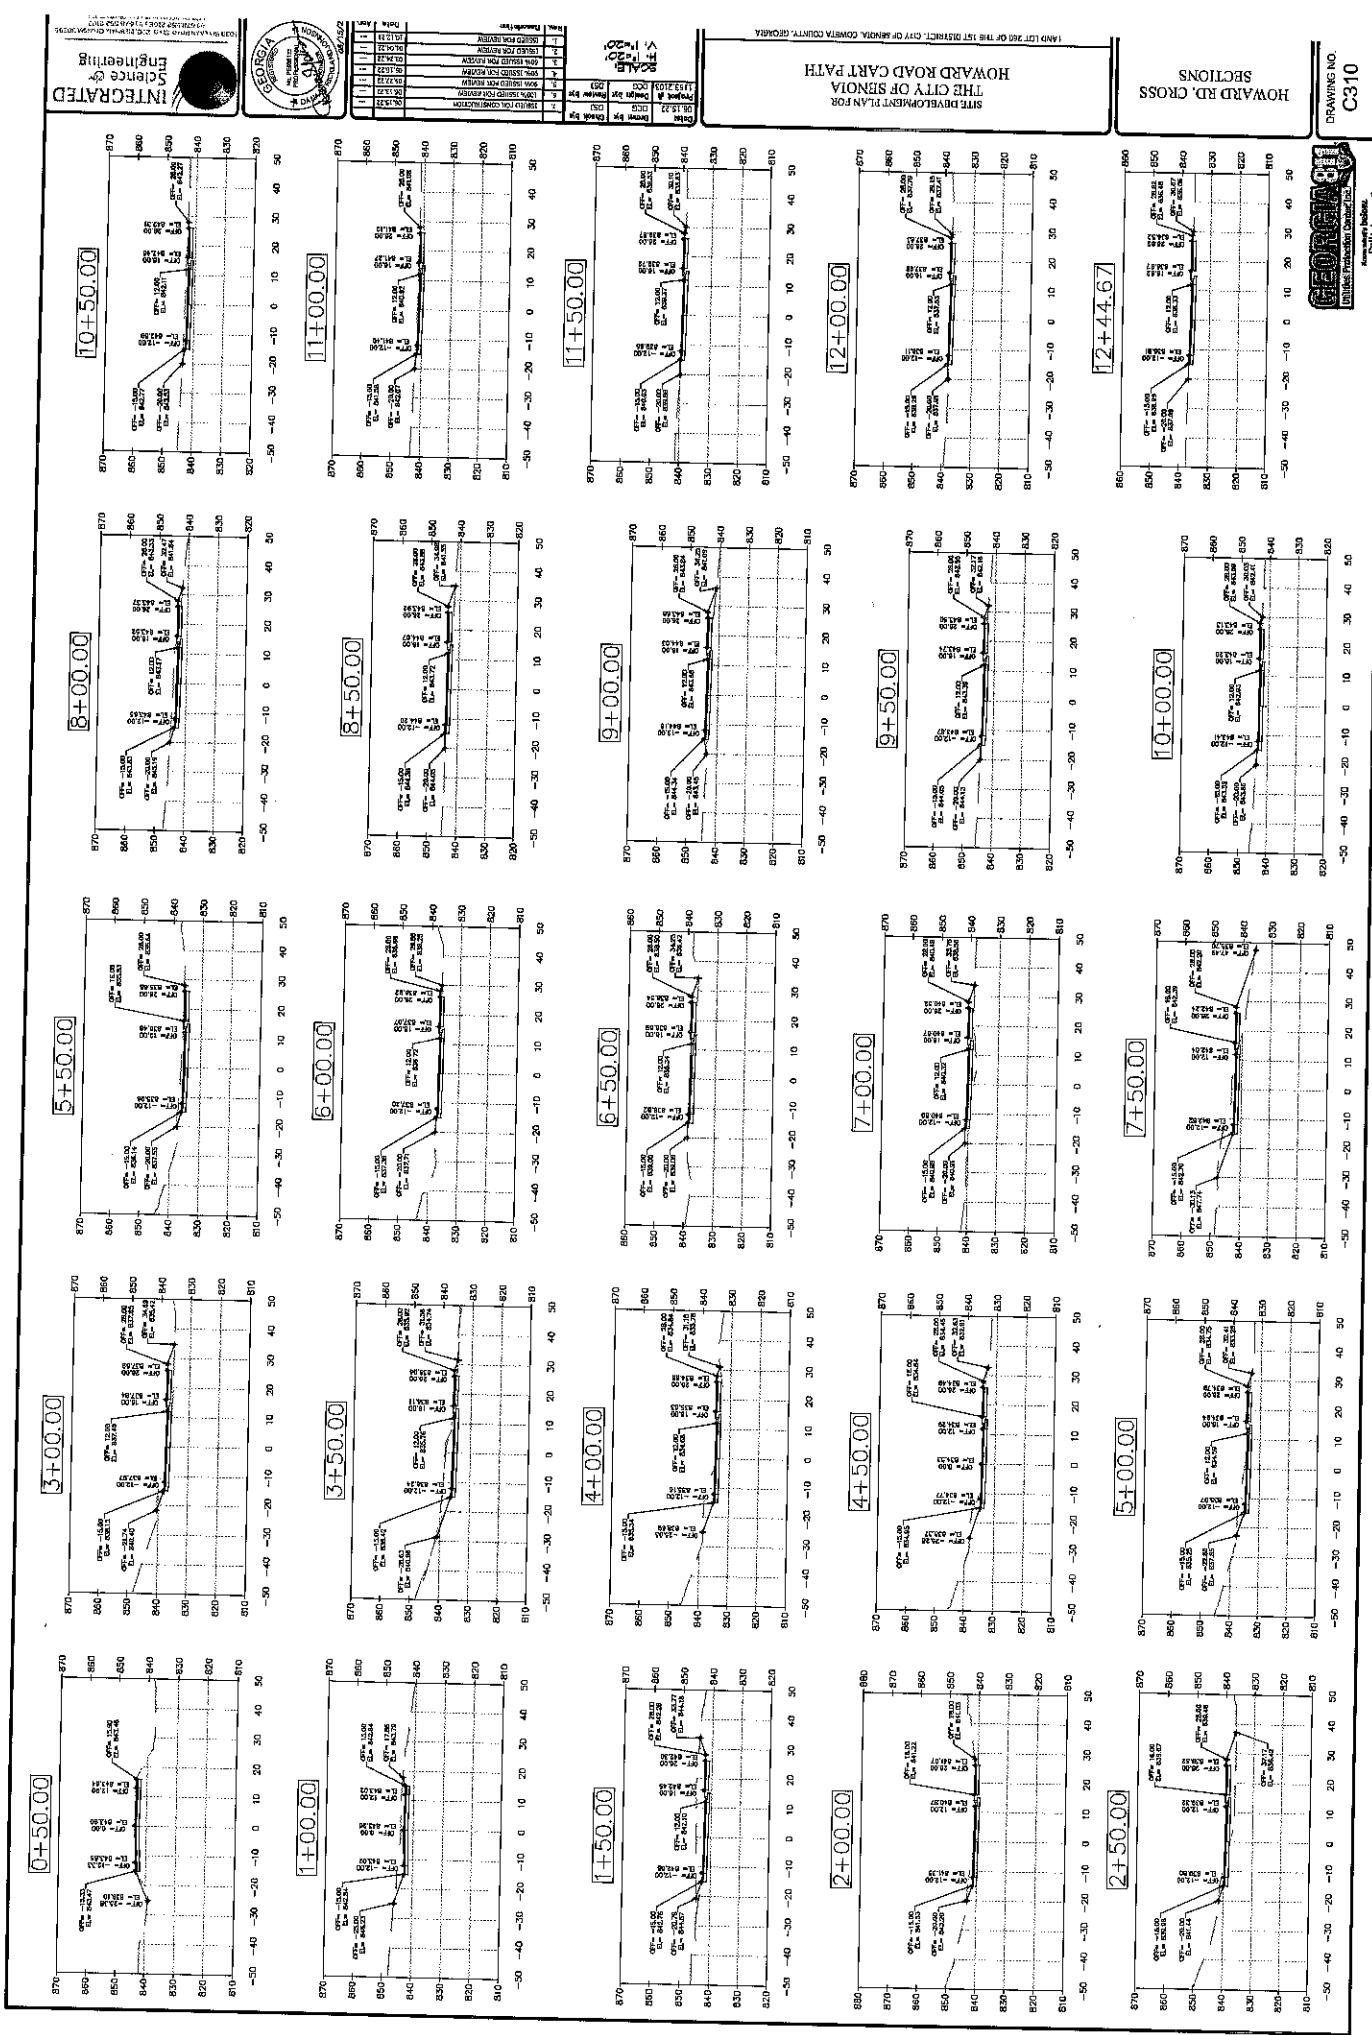


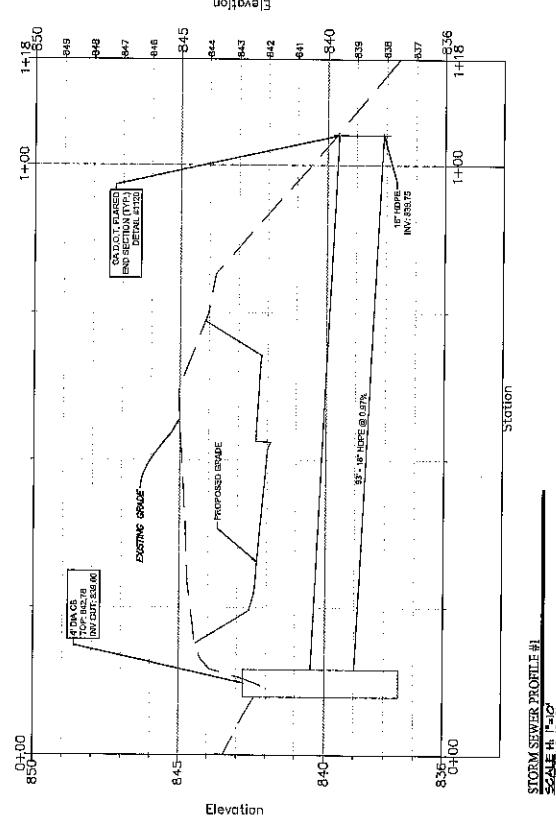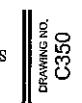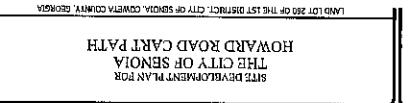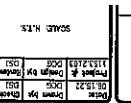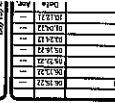

STORM SEWER PROFILE #4  
Scale: 1" = 20'

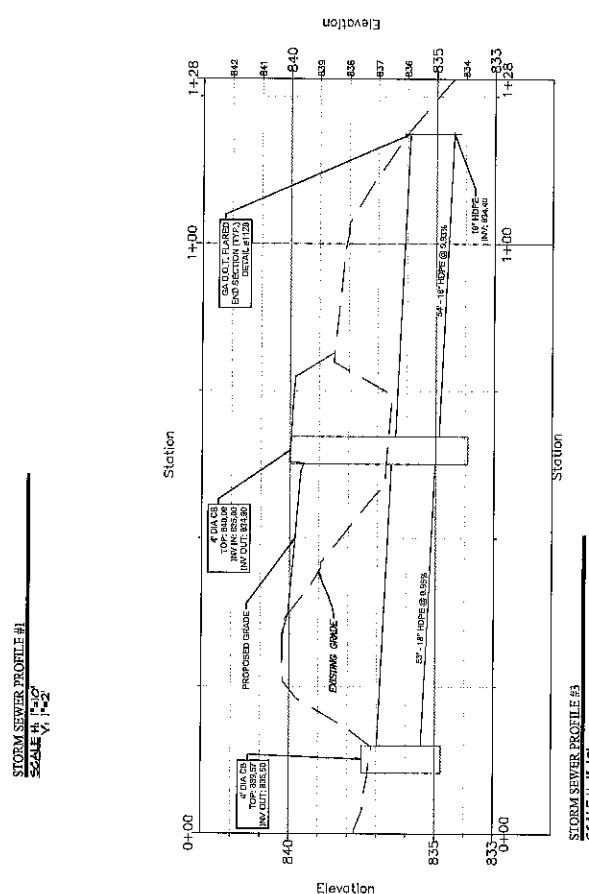

STORM SEWER PROFILE #5  
Scale: 1" = 20'

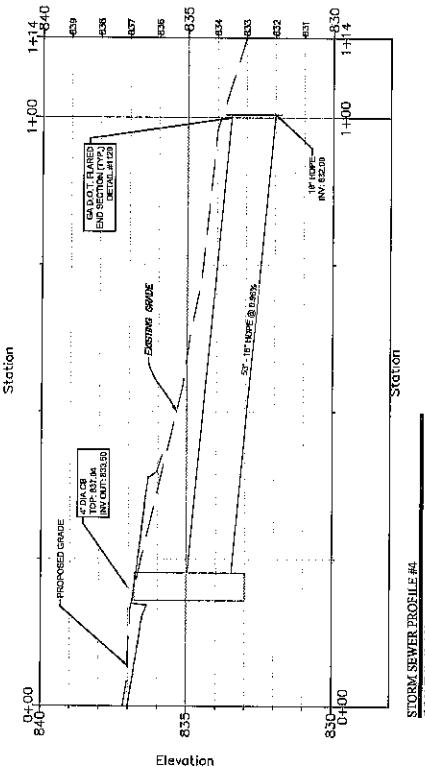


STORM SEWER PROFILE #6  
Scale: 1" = 20'



Drawing No. C350




INTEGRATED  
SCHEME &  
Engineering

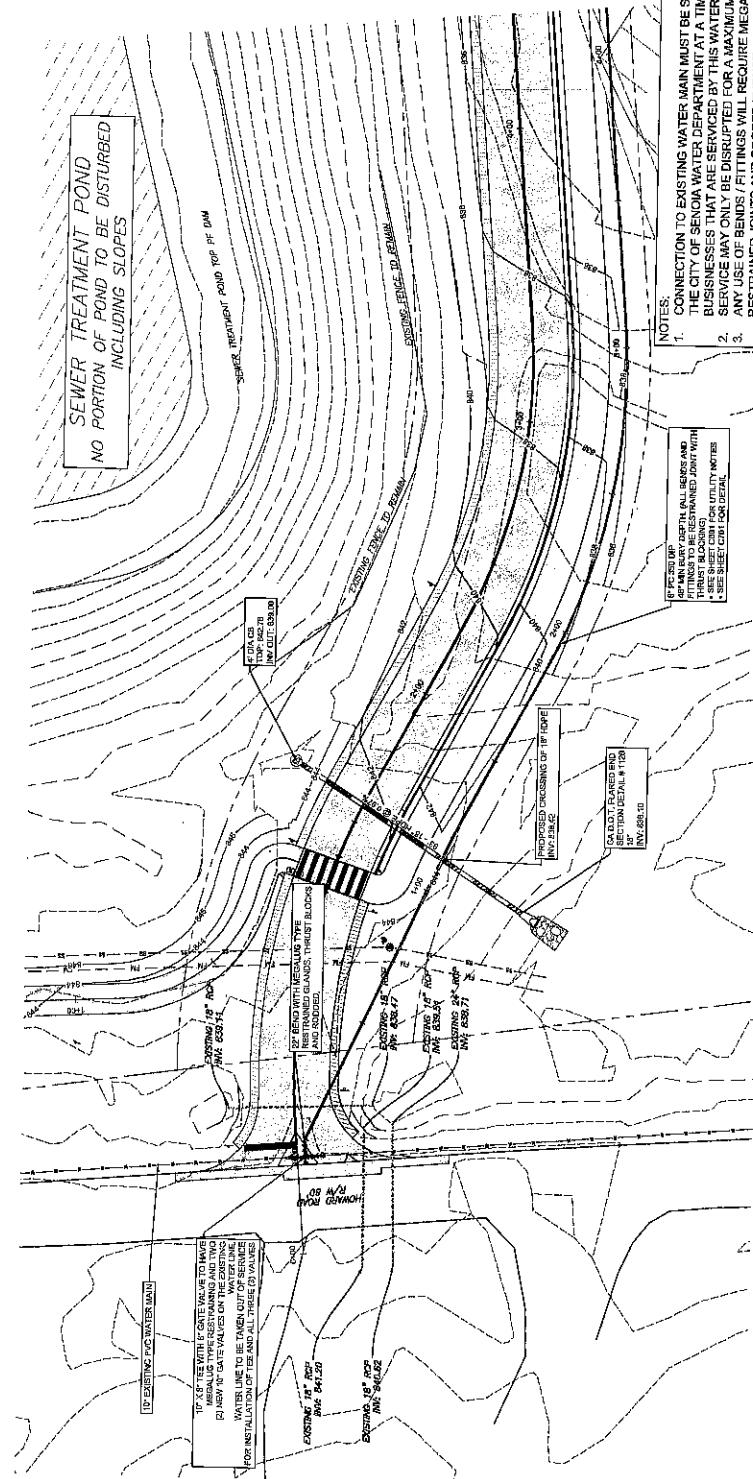

NOTES:



1. CONNECTION TO EXISTING WATER MAIN MUST BE SCHEDULED THROUGH THE CITY OF SENOIA WATER DEPARTMENT AT A TIME SUITABLE FOR THE BUSINESSES THAT ARE SERVED BY THIS WATER MAIN.
2. SERVICE MAY ONLY BE DISRUPTED FOR A MAXIMUM OF TWO HOURS.
3. ANY USE OF BENDS FITTINGS WILL REQUIRE MELLALIC TYPE RESTRAINED JOINTS AND PROPER THRUST BLOCKING.
4. CONCRETE PLACEMENT.
5. ALL FITTINGS TO BE LEFT EXPOSED UNTIL INSPECTION.
6. CALL CURTIS HINDMAN AT THE CITY OF SENOIA PRIOR TO SCHEDULE INSPECTIONS. CALL CURTIS HINDMAN (678) 877-7533

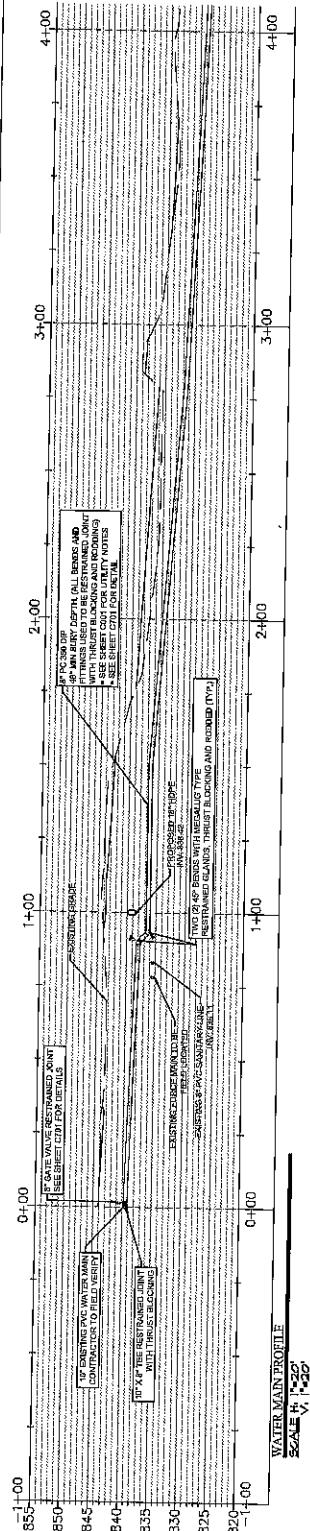

INTEGRA-TED		Schematic	
SCHMATIC		DRAWING NO.	
C401		DRAFT DATE	
CITY OF SENOIA		REVISION NUMBER	
THE CITY OF SENOIA FOR		CART PATH	
STREET DEVELOPMENT PLAN FOR		LOT 290 OF THE 1ST DISTRICT, CITY OF SENOIA, GA 30034	
HOWARD ROAD CART PATH		DRAWING NO. C401	

**NOTE:**

1. ANY USE OF BENDS / FITTINGS WILL REQUIRE RESTRAINED JOINTS AND PROPER THRUST BLOCKING.
2. ALL THRUST BLOCKING LOCATIONS SHALL BE INSPECTED BEFORE CONCRETE PLACEMENT.
3. ALL FITTINGS TO BE LEFT EXPOSED UNTIL INSPECTION.
4. CALL CURTIS HINDMAN AT THE CITY OF SENOIA PRIOR TO SCHEDULED INSPECTIONS. CALL CURTIS HINDMAN (678) 877-7533

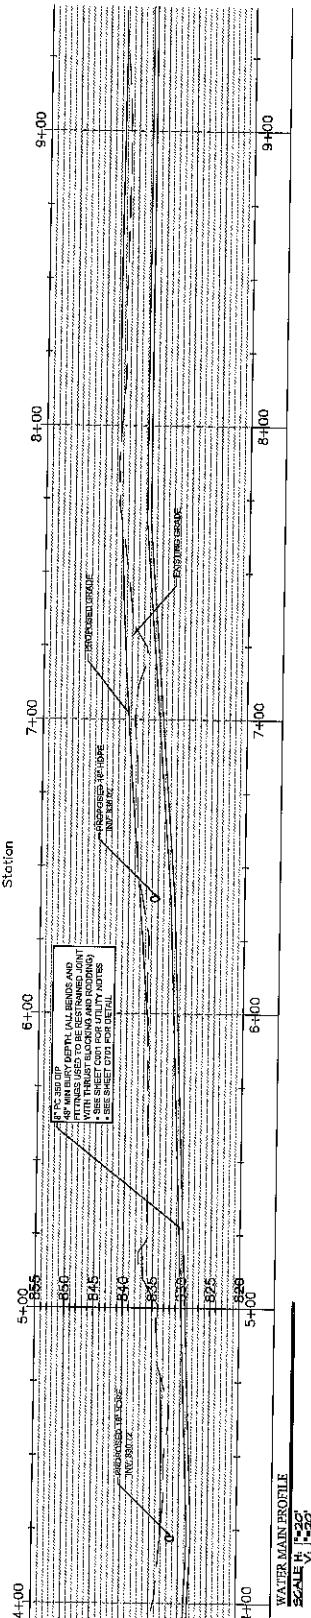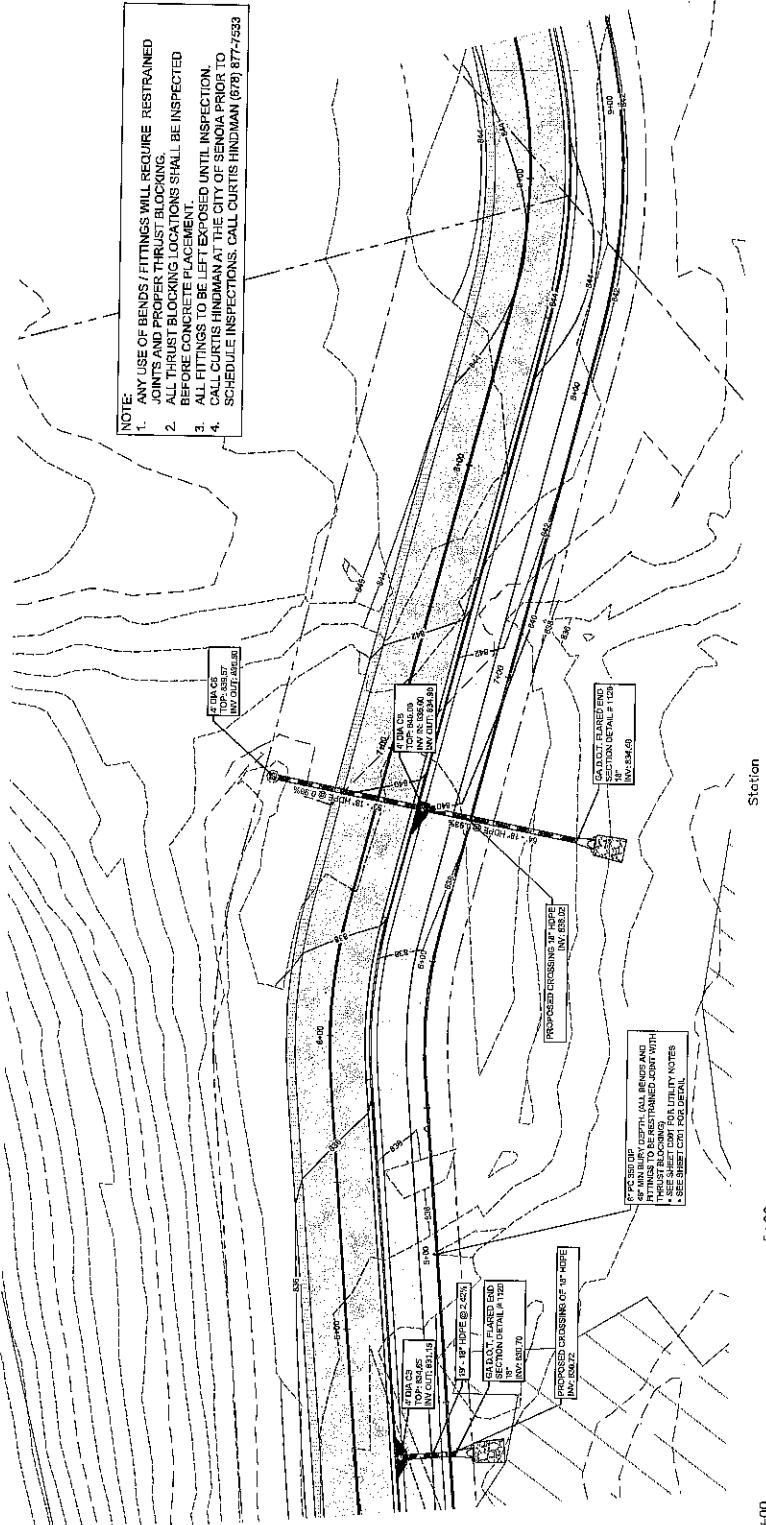



DRAWING NO.  
C401

INTEGRATED ENGINEERING		GEORGIA	
Site Development Plan		Howard Road Canal Path	
THE CITY OF SENOIA		City of Senoia, County, Georgia	
Site Development Plan		CADD 10 GP THE TEF DISTRICT, CITY OF SENOIA, COUNTY, GEORGIA	
Engineering		DRAFT	



DRAWING NO.  
C402

WATER MAIN PLAN

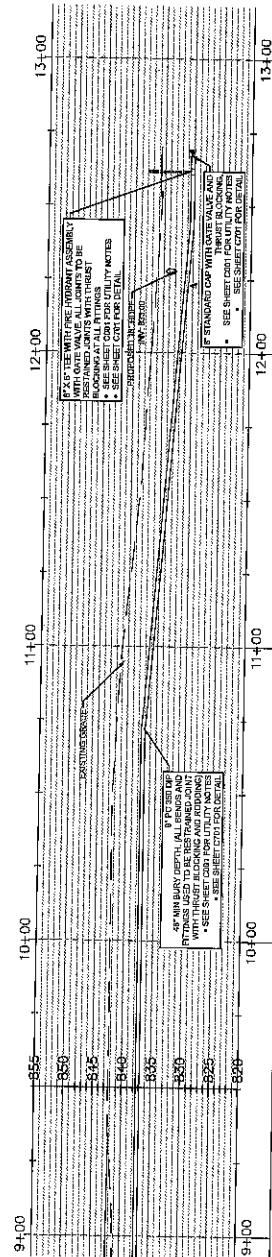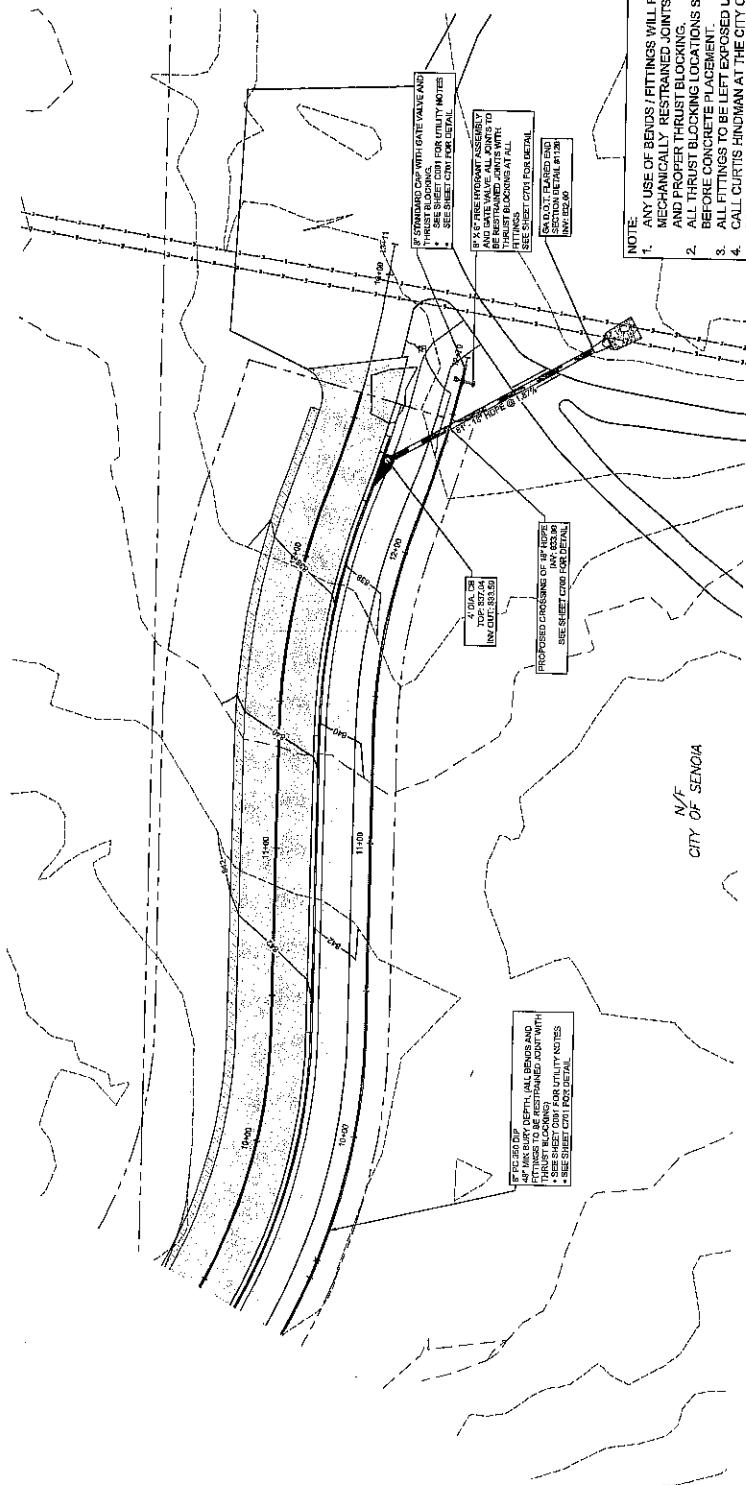

**GENERAL NOTES:**


1. OWNER: FRAZER PARTRIDGE  
CITY OF COWETA  
120 N COVETTA BLVD.  
SENKA, GA 30078  
PHONE: 770-423-0000
2. ENGINEERS/DOORS: QUALIFIED PERSONNEL  
TO BE APPROVED BY THE CITY OF COWETA AND SENOA  
BY SEAWARD ROAD CONTRACTING, INC.  
NEWTON, GA 30055  
PHONE: 770-613-1800  
FAX: 770-613-1801  
E-MAIL: NEWTON@SEAWARD.ORG  
PHONE: 770-613-1800  
FAX: 770-613-1801  
[WWW.SEWARD.COM](http://www.seaward.com)

**EROSION, SEDIMENTATION AND POLLUTION CONTROL NOTES:**


1. EROSION CONTROL: CURBS/PERMATILE  
2. DECURED AREA: 3,234 SQ.FT. TOTAL SURFACE: 5,183.25 SQ.FT. UNPAVED AREA: 0.8835 SQ.FT.
3. THE SOURCE OF SEDIMENT FROM THIS SITE SHALL BE PREVENTED BY THE INSTALLATION OF A SEDIMENT AND STORMwater CONTROL MEASURE, AND PLACED PRIOR TO LAND INTRUSION ACTIVITIES.
4. APPROVED PLACEMENTS MAY BE REQUIRED FOR ERIC, RPP, ESR, AND DR. APPROVALS ARE THE RESPONSIBILITY OF THE CONSTRUCTION TEAM.
5. ALL EROSION CONTROL MEASURES ARE TO BE MANUFACTURED AT CALL TIMES FOR LIQUIDATION OF THE CONSTRUCTION TEAM, AND NO OTHER TIME.
6. EROSION CONTROL SPARES SHOULD BE MAINTAINED AT CALL TIMES FOR LIQUIDATION OF THE CONSTRUCTION TEAM, AND NO OTHER TIME.
7. ALL APPROVED PLACEMENTS MAY BE REQUIRED FOR ERIC, RPP, ESR, AND DR. APPROVALS ARE THE RESPONSIBILITY OF THE CONSTRUCTION TEAM, AND NO OTHER TIME.
8. THE APPROVED CONSTRUCTION TEAM IS RESPONSIBLE FOR INSURANCE POLICIES AND INSURANCE COVERAGE FOR THE CONSTRUCTION TEAM. THE CONSTRUCTION TEAM IS RESPONSIBLE FOR MAINTAINING AND REPAIRING ALL CONSTRUCTION EQUIPMENT. ANY CONSTRUCTION EQUIPMENT THAT HAS BEEN DETERIORATED AS A RESULT OF CONSTRUCTION TEAM USE, OR THAT HAS BEEN EXPOSED TO CONSTRUCTION TEAM SPILLS, WILL BE REPAIRED OR REPLACED BY THE CONSTRUCTION TEAM.
9. ANY REMOVED SOILS ARE TO BE USED FOR SITE RECLAMATION AND GROUND REPAIRS.
10. INSURANCE COVERAGE PROVIDED BY THE CONSTRUCTION TEAM IS NOT TO BE USED FOR PERSONAL PROPERTY, OR TO COVER OTHER LOSSES.
11. THE CONSTRUCTION TEAM IS REQUIRED TO INSPECT THE INSTALLATION OF SEWER LINES FOR SIGNIFICANT SEWER LEAKS AND HAZARDOUS MATERIALS.
12. NO HIGH-IMPACT ACTIVITIES SHALL BE CONDUCTED WITHIN THE POINT OF DIRECT VERTEDATION OF A 20'-DEEP TEE BOX IN THE EARTH BANK, AND NO HAZARDOUS MATERIALS SHALL BE PLACED ON THE EARTH BANK WITHOUT FIRST ACQUIRING THE NECESSARY WORK PERMIT AND PERmits.
13. NO EROSION REBATE TO THE EARTH CAN WHICH CAUSES SIGNIFICANT EFFECT ON DEPARTMENTAL ATTACHMENT CAN EVER BE MADE. THE CONSTRUCTION TEAM IS REQUIRED TO KEEP THE EARTH BANK FLAT.
14. STATE WATER USE PERMIT IS REQUIRED DUE TO THE DEPARTMENTAL USE.
15. WASTE MATERIALS SHALL NOT BE DISCHARGED TO DRAINWATER EXCEPT AS AUTHORIZED BY A SECTION 404 PERMIT.
16. THE ESR PLAN IS INCONSIDERABLE DUE TO THE DEPARTMENTAL USE.
17. EROSION CONTROL MATING, S, IS RECOMMENDED ALONG STAIR STEPS OR STEPS.
18. GRAVITY DRAIN PIPES ARE LOCATED IN THE DRAINSLOT AREA AND DRAINS ARE TO BE USED AS SOON AS POSSIBLE FOR CONSTRUCTION TRAFFIC, WORKERS PARKING AND STANDBY AREAS.
19. SOLID TRASH CONTAINERS ARE TO BE USED IN THE DRAINSLOT AREA OF THE EARTH BANK.
20. IMPORTANCE OF A SOIL RADIOSOIL CONTROL MEASURES AND PRACTICES, WHETHER TEMPORARY OR PERMANENT, SHALL AT ALL TIMES BE THE RESPONSIBILITY OF THE PROPERTY OWNER.

# EROSION, SEDIMENTATION AND POLLUTION CONTROL PLANS FOR HOWARD ROAD CART PATH


LOCATED IN LAND LOT 260 OF THE 1ST DISTRICT, COWETA COUNTY, GA  
PARCEL ID NUMBER: 162 1260 018, 162 1260 001A & 162 1260 004.

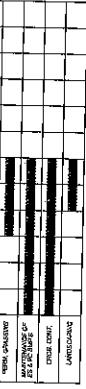

SITE LOCATION MAP (NT.S.)

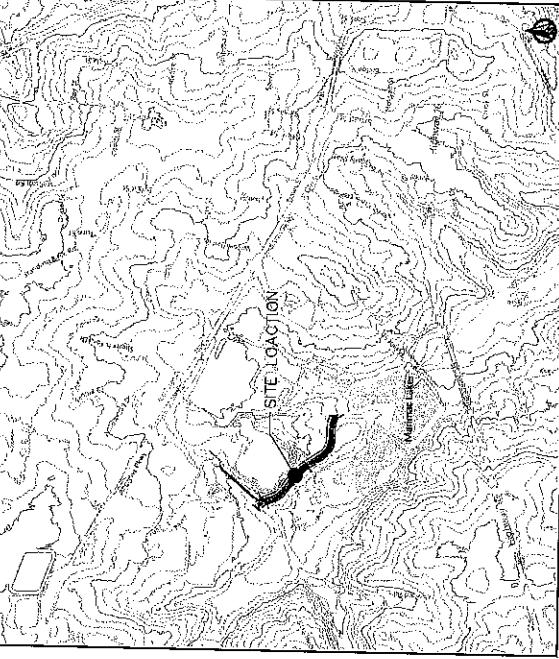

PREPARED FOR:  
**THE CITY OF SENOA**

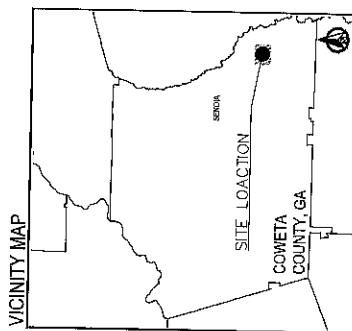**Engineer Certification**

I certify under penalty of law that this plan was prepared after a site visit to the location described herein by myself or my authorized signing agent in my supervision. I certify that the practices embodied in these management practices and Pollution Control Plan reflect the appropriate and comprehensive standard of care and management required for Erosion and Sediment Control and Stormwater Management under the applicable laws and regulations of the State of Georgia, the City of Newton, and Coweta County. I have performed this site visit to inspect the activities which were permitted, provided, or required, and the resulting work for or the design professional of record who has been retained to inspect the requirements contained in the SITES DEVELOPMENT PLAN (SDP) and/or the ESR/RR/RSR.

Design professional of record who has been retained to inspect the construction work done prior to this start date.

DINA S. JOHNSON, PE #E-26533 GSEPC-2-1796

**Permittee Certification**

I certify under penalty of law that the standards and all actions herein were prepared under my direction and control. I have reviewed and approved the practices and methods for erosion and sediment control described in this plan. I am responsible for the implementation of these controls and I will manage the system to the best of my knowledge and belief. I have, or am, in contact with my design professional, including design information, including the possibility of fine and/or commitment for non-compliance.

FIRM: FTE

PROJECT ACTIVITY SCHEDULE (Anticipated Start Date - June 2004)						
	1	2	3	4	5	6
CONTRACTOR						
TOPOGRAPHIC SURVEY						
DEMOLITION						
JOBSITE PREPARATION						
BROWNSVILLE						
APPROVALS						
WORK SPAZZLE						
MANUFACTURING OF ESR/RR/RSR						
DRILLING CONCRETE						
LAWNCARE						

LAND LOT 260 OF THE 1ST DISTRICT, CITY OF SENOA, COWETA COUNTY, GA  
SITES DEVELOPMENT PLAN (SDP)  
HOWARD ROAD CART PATH


COVER SHEET  
EROSION CONTROL  
DRAWING NO.  
C500

DRAWING INC.  
DINA S. JOHNSON, PE  
CAPE BR13  
GSWCC LEVEL 1#1794  
RECEIVED: 4/13/2004  
PRINTED: 4/13/2004  
100% Scale Only




INTTEGRATED		Engineering		Clientele	
STATE DEVELOPMENT ELAN FOR THE CITY OF SENOIA					
HOWARD ROAD CART PATH					
LAND LOT #60 OF THE 1ST DISTRICT, CITY OF SENOIA, COVETA COUNTY, GEORGIA					
DRAINEAGE BASINS		PRE-DEVELOPMENT		DRAWING NO.	
GEORGIA		C503			

(c) DANA S. JOHNSON PE  
GA #E-365103  
GSNCC LEVEL II #7784

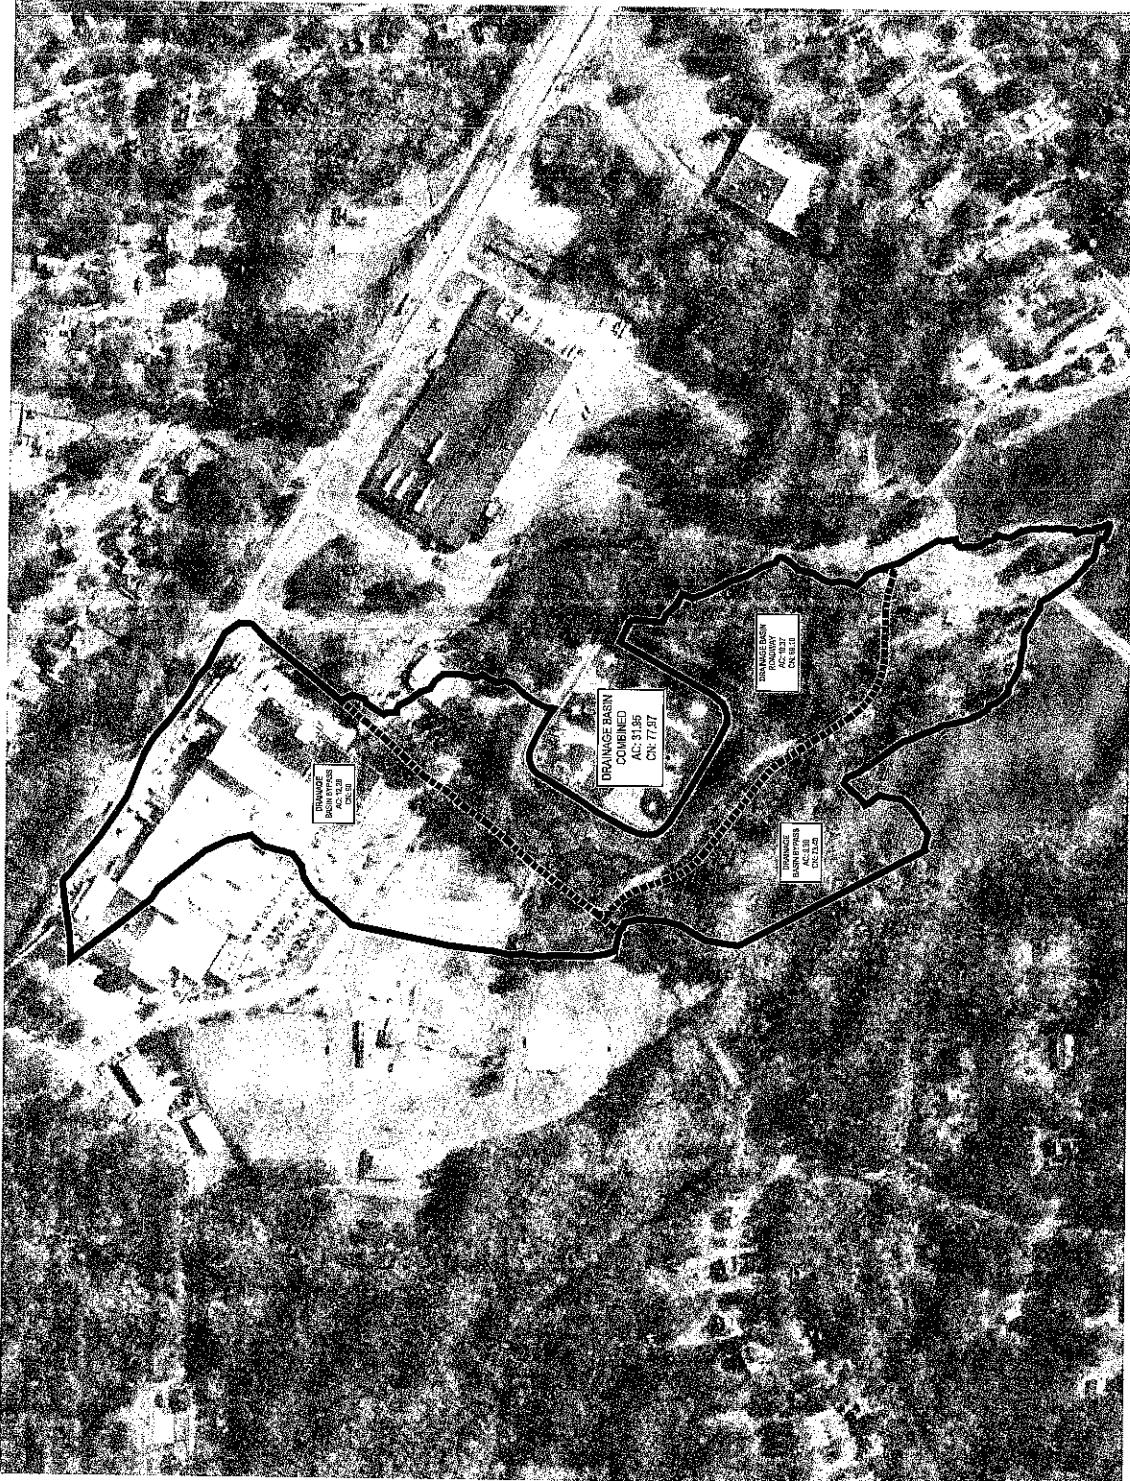

INTEGRADE		Engineering	
POST-DEVELOPMENT DRAINAGE BASIN			
THE CITY OF SNYDER STATE DEVELOPMENT PLAN FOR HOWARD ROAD CART PATH			
LARGE LOT 220 OF THE 1ST DISTRICT CITY OF SNYDER, COLUMBIAN COUNTY, GEORGIA			
DRAWING NO. C504			
DRAWA S. JOHNSON, PE GA PE #8613 GSWCC LEVEL II #1794			
GEORGIA GOVERNMENT PRINTING AND COMMERCE CITY OF SNYDER			

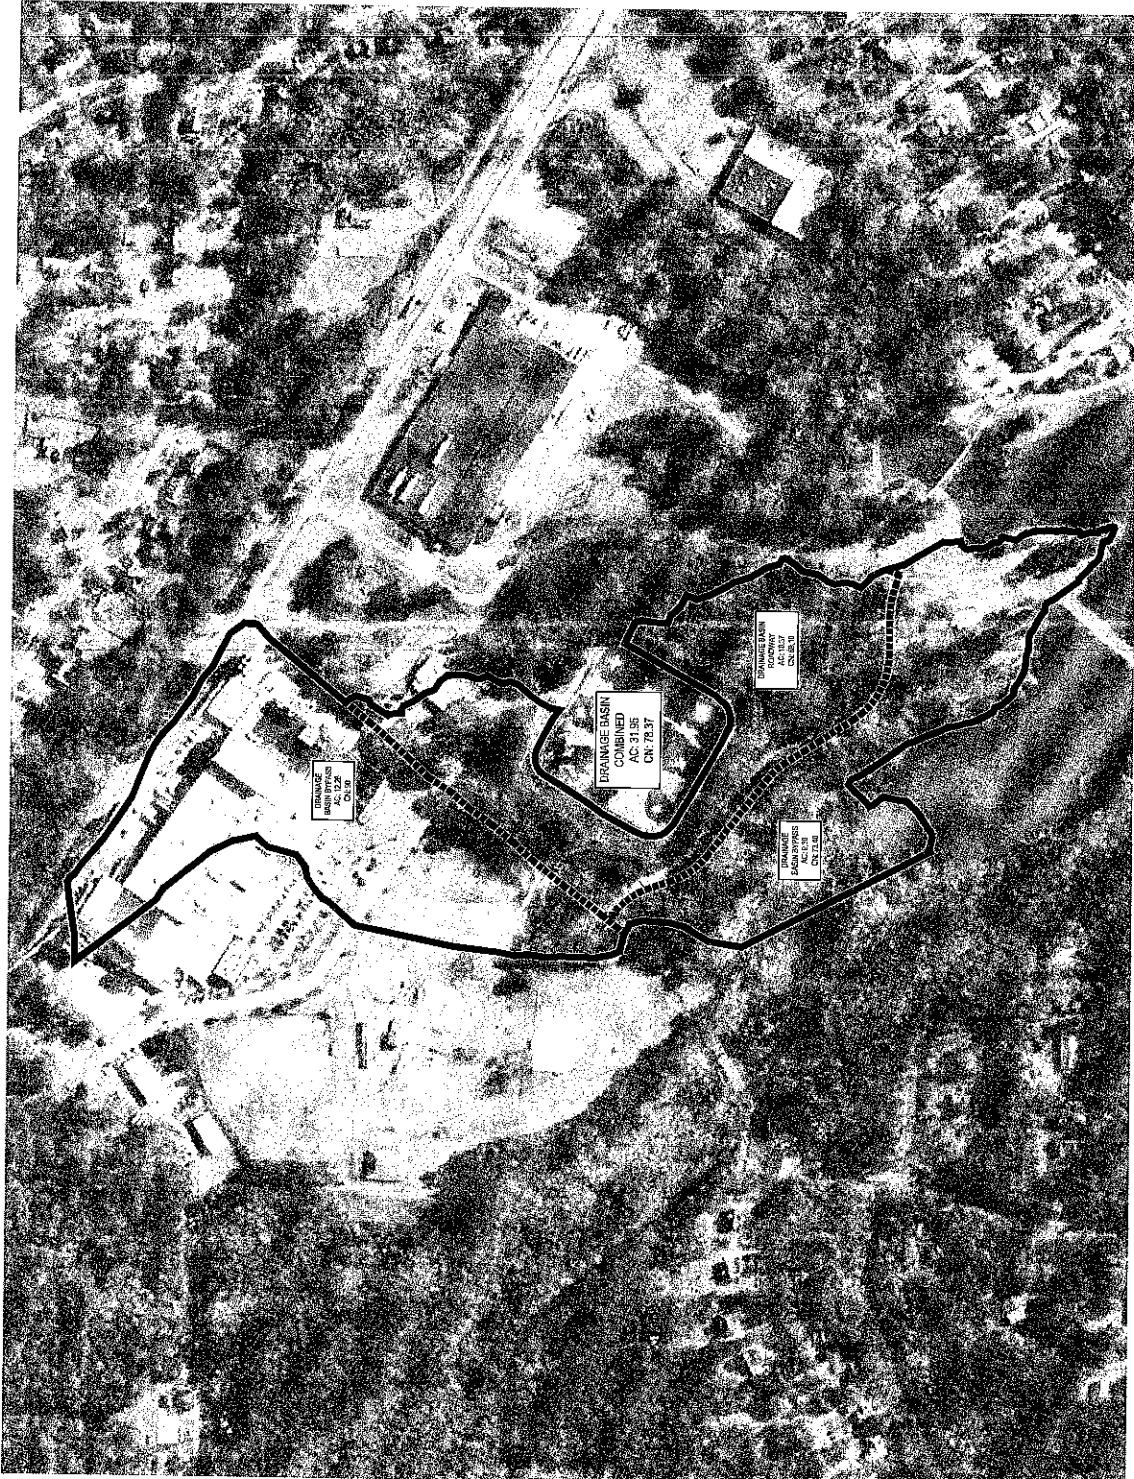

INTTEGRATED Schematic		Engineering	
 <b>GEORGIA</b> STATE DIVISION OF ENVIRONMENTAL MANAGEMENT 1100 Peachtree Street, N.E. Atlanta, Georgia 30367 (404) 656-2700 FAX: (404) 656-2701 TDD: (404) 656-2702 E-mail: <a href="mailto:info@doe.state.ga.us">info@doe.state.ga.us</a> Web site: <a href="http://www.doe.state.ga.us">www.doe.state.ga.us</a>			
 <b>HOWARD COUNTY, MARYLAND</b> 100 W. Main Street, Suite 200 Ellicott City, Maryland 21042 (301) 961-1100 FAX: (301) 961-1101 E-mail: <a href="mailto:info@howardcountymd.gov">info@howardcountymd.gov</a> Web site: <a href="http://www.howardcountymd.gov">www.howardcountymd.gov</a>			
<b>INITIAL PHASE SITEMANAGEMENT PLAN CONTROLL PLAN</b> 1100 Peachtree Street, N.E. Atlanta, Georgia 30367 (404) 656-2700 FAX: (404) 656-2701 TDD: (404) 656-2702 E-mail: <a href="mailto:info@doe.state.ga.us">info@doe.state.ga.us</a> Web site: <a href="http://www.doe.state.ga.us">www.doe.state.ga.us</a>			

1100 PEACHTREE STREET, N.E., SUITE 150, ATLANTA, GA 30367  
 (404) 656-2700 • FAX: (404) 656-2701 • TDD: (404) 656-2702  
 E-mail: [info@doe.state.ga.us](mailto:info@doe.state.ga.us) • Web site: [www.doe.state.ga.us](http://www.doe.state.ga.us)

DRAWING NO.  
**C510**



Georgian  
Engineering  
Division of Environmental Management


### STRUCTURAL PRACTICES


CODE/PRACTICE	DETAIL	MAP SYMBOL	DESCRIPTION
(C1)	GRADE		A well known grade line or contour line which has been established by survey or other means.
(C2)	CONSTRUCTION LINE		A straight line placed on the ground surface to provide a straight line for construction work.
(C3)	STORM DRAINS		A series of pipes or pipes connected together to collect surface water runoff.
(C4)	STRUCTURAL PROTECTION		A series of trees, shrubs, or other vegetation used to protect structures from the movement of earth.



### VEGETATIVE PRACTICES

CODE/PRACTICE	DETAIL	MAP SYMBOL	DESCRIPTION
(DS1)	BROWNS AND GREENS		Establishing temporary practices for disturbed areas where no trees, grass, or other vegetation are present in order to reduce erosion.
(DS2)	INTERIM PLANTING		Establishing temporary vegetation cover on disturbed areas.
(DS3)	SOIL STABILIZATION		Soil test, grading, seed, mulch, or other measures to stabilize soil.

LEGEND	EXISTING CONTURS
—	EXISTING INDEX CONTURS
- - -	PROPOSED INDEX CONTURS
—	PROPOSED INTERVAL CONTURS
—	PROPOSED SALT FENCE
—	TREE PROTECTION FENCE
—	LINE OF DISTURBANCE
—	SOLIS LISTS
—	DRIVEWAY BURN

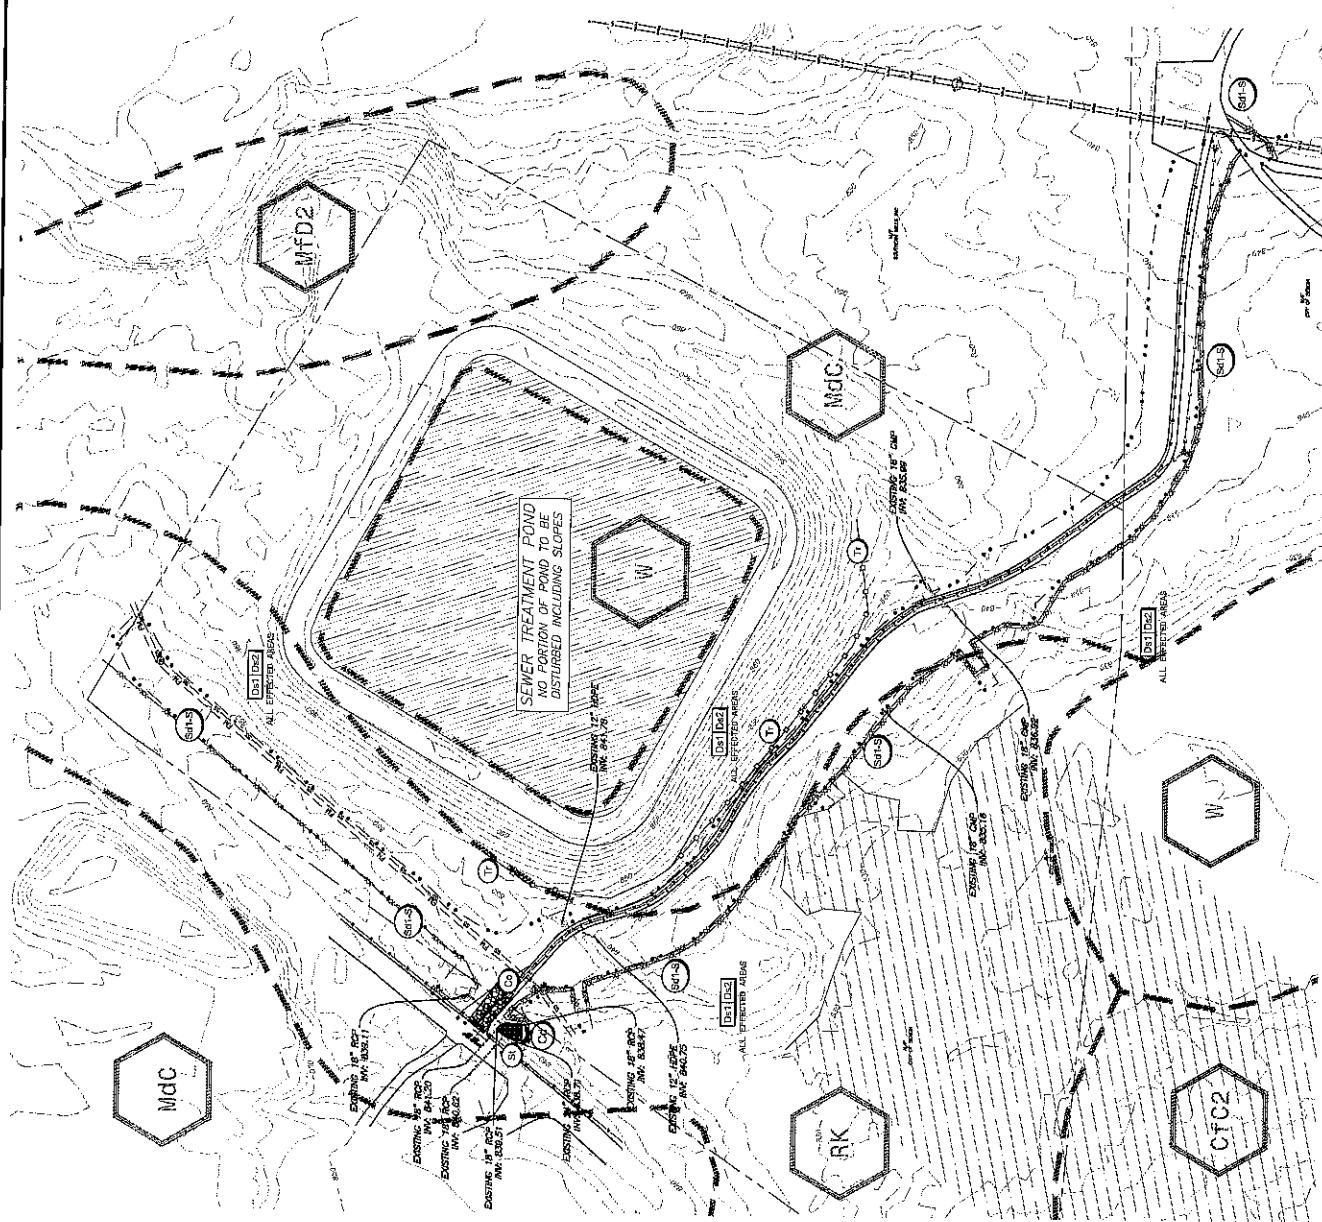

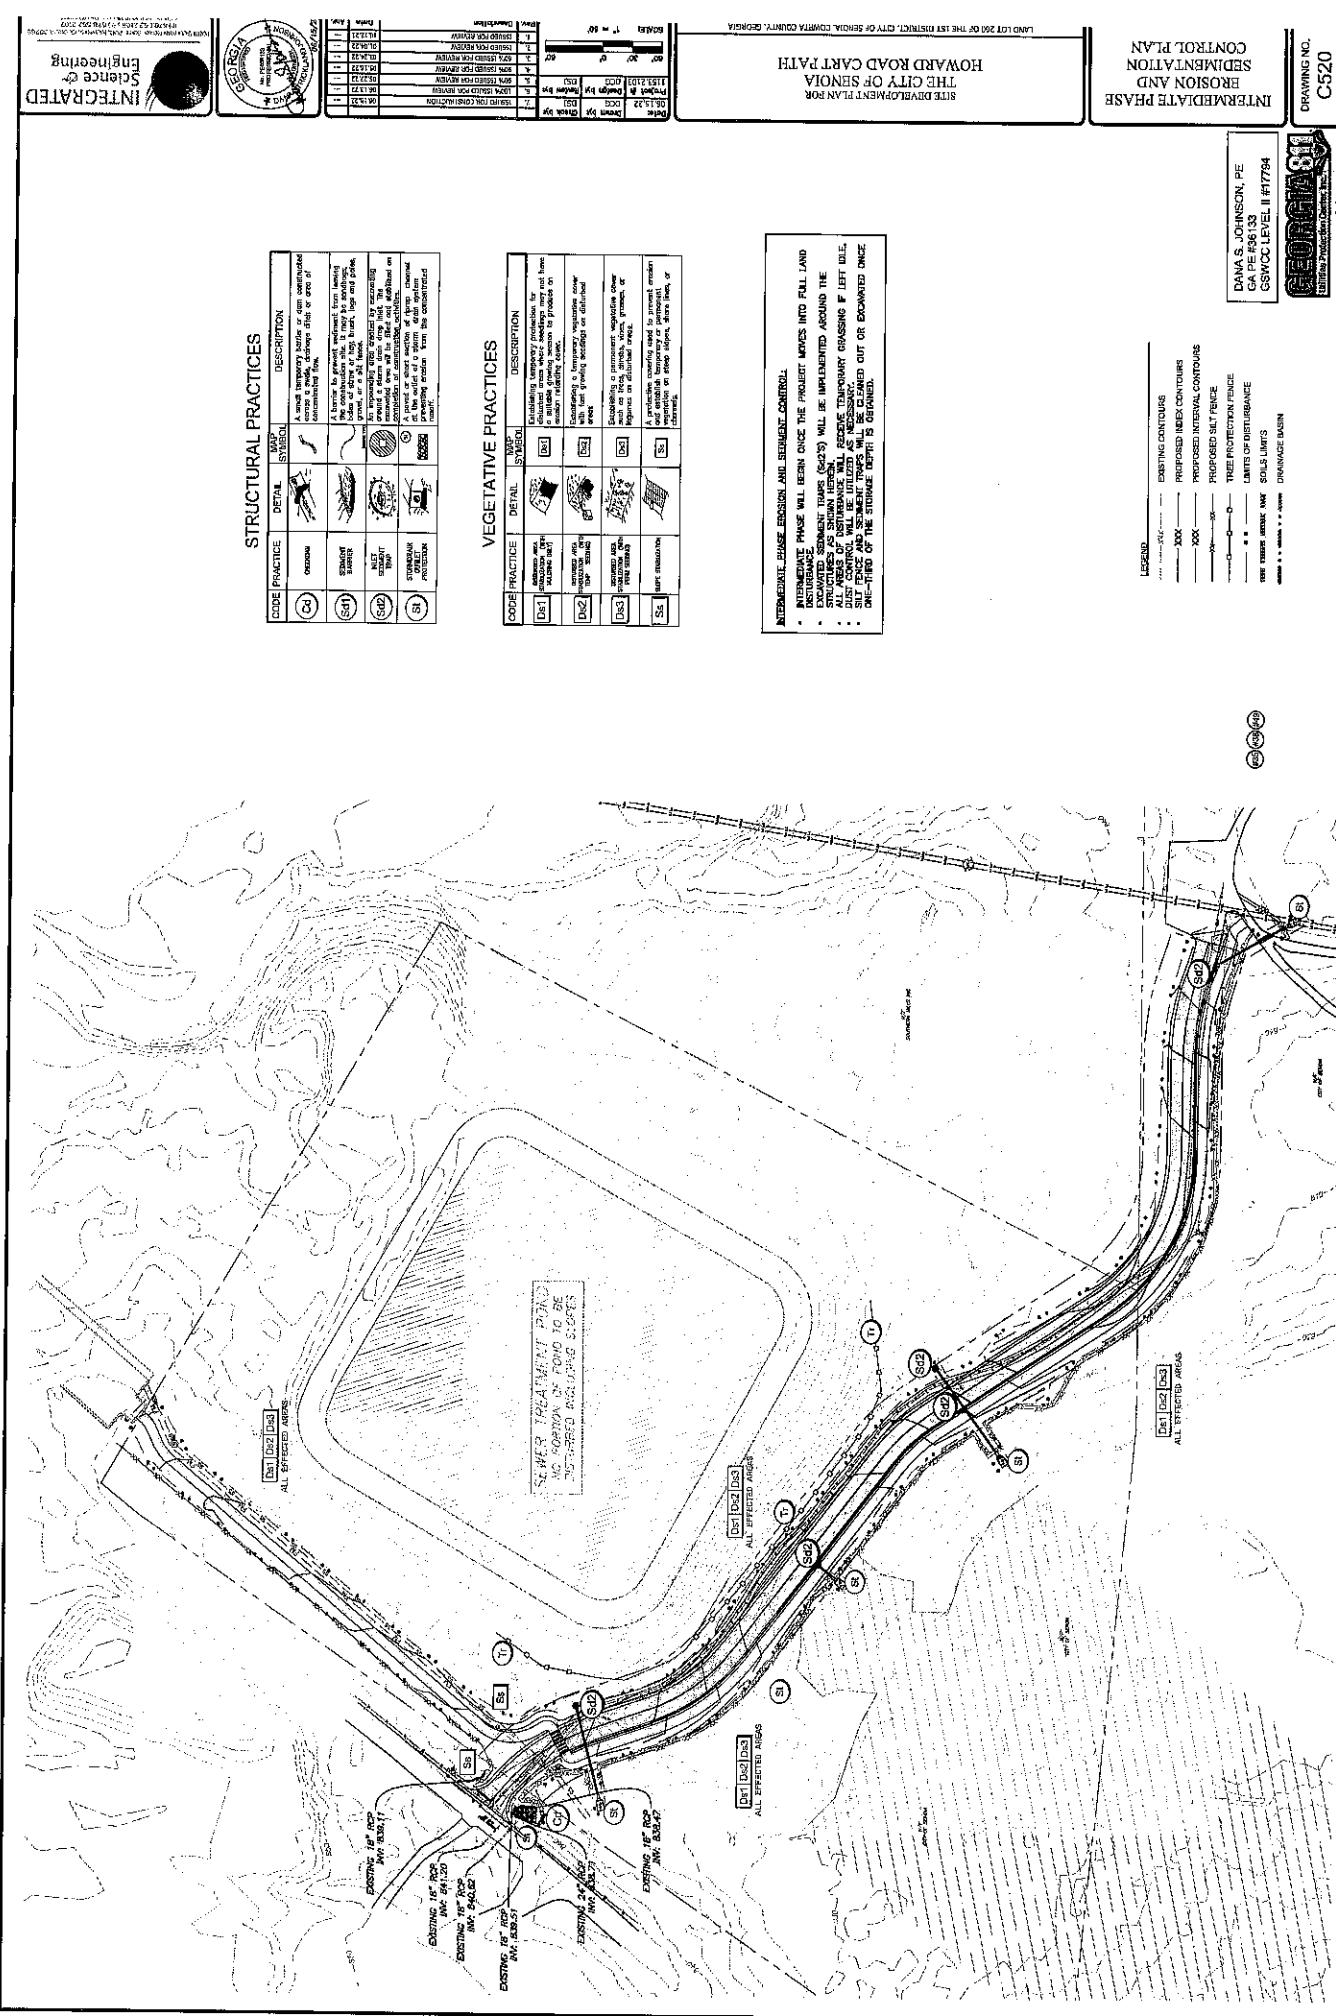

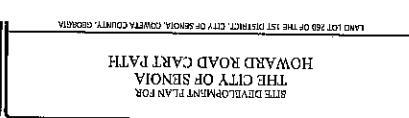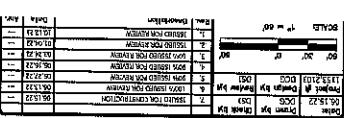

FINAL PHASE EROSION  
AND SEDIMENTATION  
CONTROL PLAN

DRAWING NO.  
C530



### STRUCTURAL PRACTICES

CODE	PRACTICE	DETAIL	WPS	SYMBOL
D3	STABILIZATION PROTECTION	Stabilization of steep embankments or the edges of a stream, ditch, or other watercourse areas from the concentrated flow of surface runoff.	100	100
D4	STABILIZED AREA GROOVES	A permanent, vegetative cover strip such as native grasses, trees, or shrubs installed along a stream, ditch, or other watercourse area.	100	100
S1	SLACK STABILIZATION	A relatively flat area where soil is present, vegetative cover is installed forming a slope, native grass, or vegetation on steep slopes, ditches, or watercourses.	100	100

### VEGETATIVE PRACTICES


CODE	PRACTICE	DETAIL	WPS	SYMBOL
D3	RESCUE PLANTING	Established or permanent vegetative cover such as trees, shrubs, vines, grasses, or other plants installed on disturbed areas.	100	100
D4	PERMANENT VEGETATION	A permanent, vegetative cover strip such as native grasses, trees, or shrubs installed along a stream, ditch, or other watercourse area.	100	100
S1	SLACK STABILIZATION	A relatively flat area where soil is present, vegetative cover is installed forming a slope, native grass, or vegetation on steep slopes, ditches, or watercourses.	100	100

LEGEND	EXISTING CONTOURS	PROPOSED DREDGE CONTOURS
—	—	XXX
—	—	XXX
—	—	PROPOSED INTERNAL CONTOURS
—	—	PROPOSED SILT FENCE
—	—	TREE PROTECTIVE FENCE
—	—	LIMITS OF DISTURBANCE
X	X	X
NEW ANVIL AREA	SILLS LAVES	DRAINAGE DITCH
—	—	—






FINAL PHASE EROSION AND SEDIMENT CONTROL:

- THE FINAL PHASE DROPPES ONCE THE SITE IS PAID AND FULLY STABILIZED WITH PERMANENT GRASSING. ALL SEDIMENT TRAPS WILL BE REMOVED.
- ALL SITE FILL IS STABILIZED TO A MAXIMUM SLOPE OF 1:1.5. ALL SOILS ARE TO BE FLUSHED/WR WASHED PRIOR TO TURN-OVER.

DANA S. JOHNSON, PE  
CA #5673  
GSWC CLEVELAND #17794

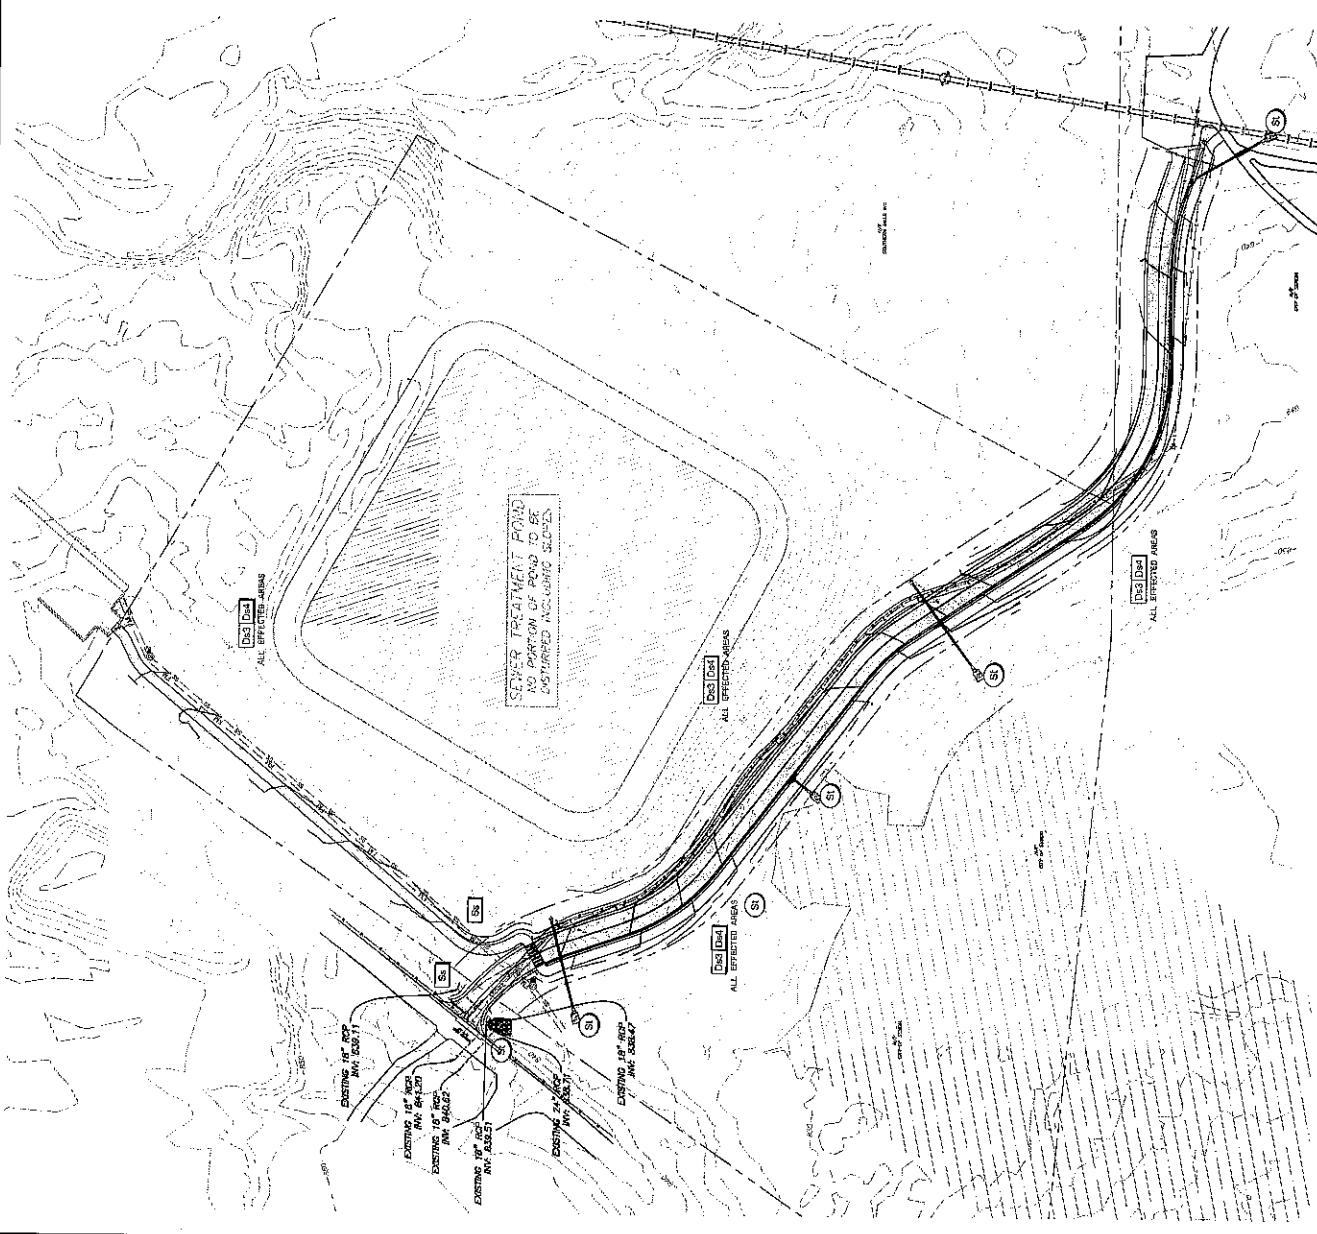

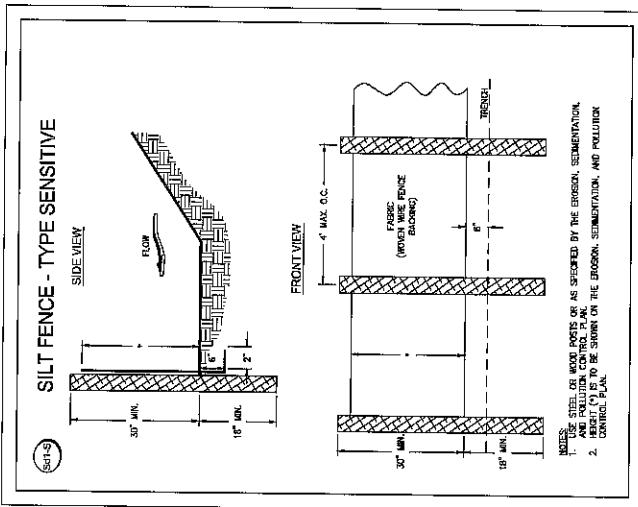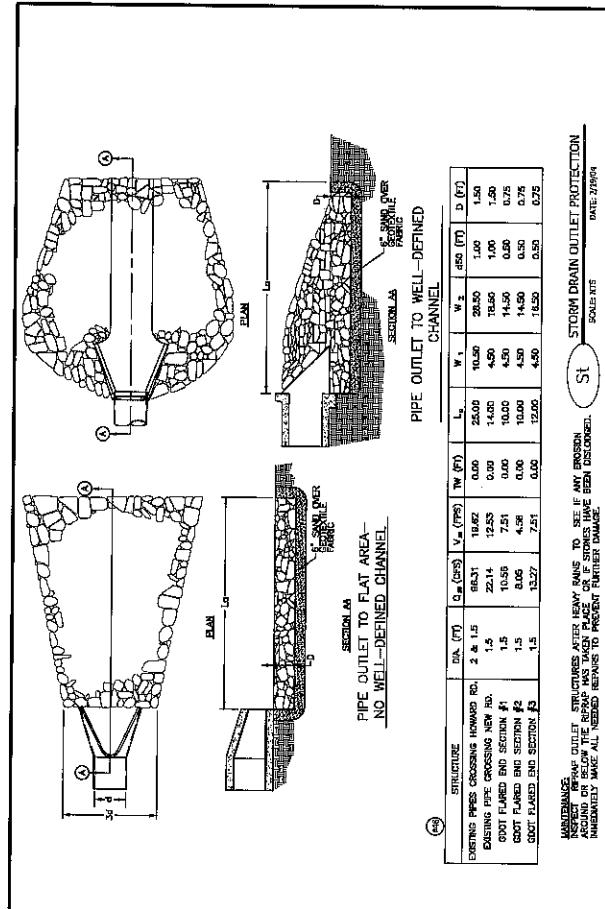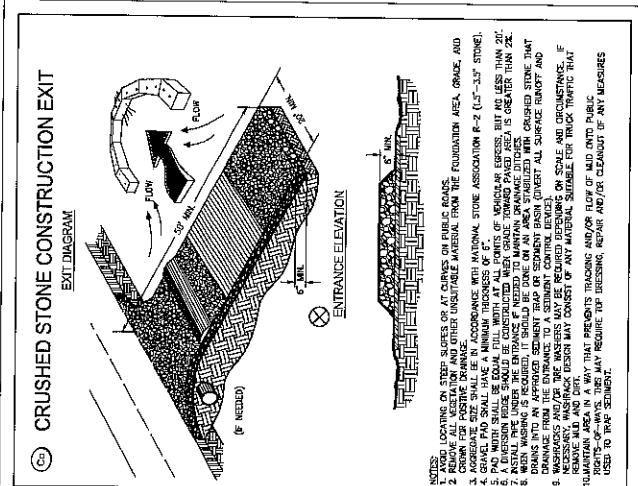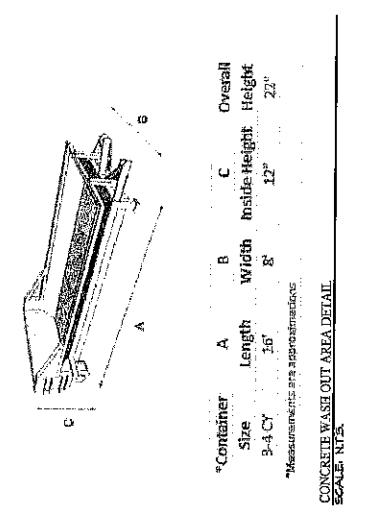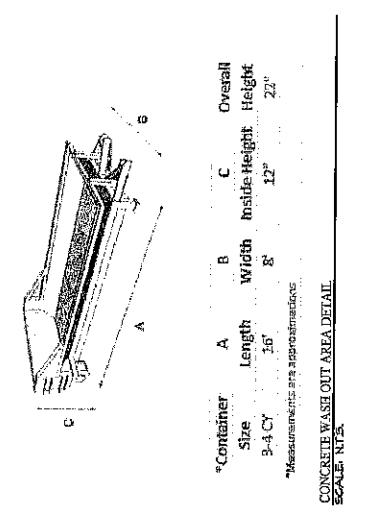

 <b>STATE DEVELOPMENT PLAN FOR</b> <b>THE CITY OF SNELLVILLE</b> <b>HOWARD ROAD CART PATH</b> <b>Site Plan</b> <b>Engineering Services</b> <b>INTEGRATED</b>		 <b>LAW OFFICES OF THE STATE ATTORNEY GENERAL, CITY OF GEORGIA, COVINGTON, GEORGIA</b>	
<b>EROSION DETAILS</b>			
<b>SILT FENCE - TYPE SENSITIVE</b> 		<b>PIPE OUTLET TO WELL-DEFINED CHANNEL</b> 	
<b>CRUSHED STONE CONSTRUCTION EXIT</b> 		<b>STORM DRAIN OUTLET PROTECTION</b> 	
<b>STRUCTURE</b> <b>DIA. (FT)</b> <b>C<sub>1</sub> (CHS)</b> <b>V<sub>0</sub> (FPS)</b> <b>TW (FT)</b> <b>L<sub>0</sub></b> <b>W<sub>1</sub></b> <b>z</b> <b>d<sub>50</sub> (FT)</b> <b>D (FT)</b> <b>EXISTING PIPES CROSSING HOWARD RD.</b> <b>2 &amp; 15</b> <b>68.311</b> <b>10.62</b> <b>22.14</b> <b>12.85</b> <b>0.00</b> <b>25.00</b> <b>10.50</b> <b>20.50</b> <b>1.00</b> <b>1.50</b> <b>COOT FLARED END SECTION #1</b> <b>1.5</b> <b>10.55</b> <b>7.51</b> <b>0.00</b> <b>14.00</b> <b>4.50</b> <b>10.50</b> <b>10.50</b> <b>1.00</b> <b>1.50</b> <b>COOT FLARED END SECTION #2</b> <b>1.5</b> <b>10.55</b> <b>7.51</b> <b>0.00</b> <b>14.00</b> <b>4.50</b> <b>10.50</b> <b>10.50</b> <b>1.00</b> <b>1.50</b> <b>COOT FLARED END SECTION #3</b> <b>1.5</b> <b>13.27</b> <b>7.51</b> <b>0.00</b> <b>12.00</b> <b>4.50</b> <b>10.50</b> <b>10.50</b> <b>0.55</b> <b>0.75</b>			
<b>NOTES:</b> 1. USE STEEL OR WOOD RODS OR AS SPECIFIED BY THE EROSION, SEDIMENTATION, AND POLLUTION CONTROL PERMIT (C) IS TO BE SHOWN ON THE EROSION, SEDIMENTATION, AND POLLUTION CONTROL PLAN. 2. ALL POLLUTION CONTROL PERMIT (C) IS TO BE SHOWN ON THE EROSION, SEDIMENTATION, AND POLLUTION CONTROL PLAN.			
<b>ST</b> <b>SOURCE XTS</b> <b>DATE: 7/7/04</b> <b>DRAFTER:</b> <b>DAN S. JOHNSON, PE</b> <b>GSWCC LEVEL II #17784</b>			
<b>CONCRETE WASH OUT AREA DETAIL</b> 			
<b>SCALE: NTS</b> <b>DRAWING NO.:</b> <b>C601</b> <small>PRINTED ON 07/07/2004 BY COVINGTON, GA</small>			



